

New Project Information

The City of Rocklin has begun processing the below referenced application(s) for project approval. The request is now being reviewed for compliance with the requirements and regulations of relevant City, State, and Federal agencies, and Utility providers. Once any issues have been resolved notice will be provided to alert neighbors and interested parties of the availability of project information, the opportunity to comment on a project, and of any pending review or action.

Application Received: August 24, 2018

Project Name and Requested Approvals:

QUICK QUACK CAR WASH AT SIERRA COLLEGE BLVD DESIGN REVIEW, DR2018-0008 USE PERMIT, U2018-0006

Staff Description of Project:

This application is a request for approval of a Design Review and Use Permit to allow construction and operation of a new 3,272 square foot self-service car wash and a 238 square foot associated office building, as well as related site improvements, on the front (eastern) portion of a 0.93-acre site, directly adjacent to Sierra College Boulevard. The project would include a pay canopy, vacuum canopies, a vacuum enclosure, trash enclosure, and wash tunnel.

Location:

The subject site is located on the west side of Sierra College Boulevard at the SW intersection of Sierra College Boulevard and the future extension of Dominguez Road. APN 045-052-026.

Existing Land Use Designations:

The property is zoned Planned Development Commercial (PD-C) within the Sierra College General Development Plan.

The General Plan designation is Retail Commercial (RC).

This project ____ does / _XX_ does not require modification or change of the land use designations and regulations currently applicable to the project site.

Compliance with the California Environmental Quality Act:

A preliminary review of this project pursuant to the California Environmental Quality Act (CEQA) has tentatively identified a Mitigated Negative Declaration as the appropriate level of environmental review for this project.

Applicant & Property Owner:

The applicant is Quick Quack Developments, LLC (Efrain Corona). The property owner is Martin A. Harmon, Trustee of Crosswinds Trust.

Attached Information:

For additional detail please see the attached information from the project application form and the submitted application exhibits.

P:\PUBLIC PLANNING FILES\BVF\Special Projects\Website Posting of Referals\Background Information & Project Description.docx



City of Rocklin

Planning Division 3970 Rocklin Road Rocklin, California 95677 Phone (916) 625-5160 FAX (916) 625-5195 UNIVERSAL APPLICATION FORM

NAME OF PROJECT: Quick	Quack Car Wash		
LOCATION: Sierra Colle	ege Blvd.		
Assessor's Parcel Numbers	<u>045-052-026-000</u>		
DATE OF APPLICATION (STAFF		VED BY (STAFF INITIALS):	
FILE NUMBERS (STAFF):	22018-0008 U.	2018-0006 \$15,845 FEES: \$6,311	
RECEIPT No.: <u>R27790</u>	, R27791		
Pre-Application Meeting R	equirements:		
processing by enabling staff materials are in the proper for ordinances that may affect the applicant's request. Generally, two sets of prelimit with the applicant to the pre-	of permits. The purpose of the to work with the applicant of the project. A copy of these linary plans and a written description meeting. To schedup propert Department by calling (Staff Planner prior to submitting most applications a pre-application meeting is to expedite application to assure that the officially submitted application inderstands the City of Rocklin's goals, policies, and and other planning provisions is available at the cription of the proposed project should be brought dule this meeting, please contact a Staff Planner at (916) 625-5160.	
THIS APPLICATION IS FOR THE	FOLLOWING ENTITLEMENTS: (C	HECK APPROPRIATE SQUARES)	
☐ General Plan Amendment (GPA) Fee: \$11,434 (< 100 Acres) \$ 2,565 (each add1 100 Acres)	☐ Tentative Subdivision Map (SE Fee: \$17,715 (1st 50 lots) \$2,188 (each add 150 lots) \$10,337 Modification	☐ Minor (PC Approval – New Bldg) Fee: \$9,888	
☐ Rezone (Reclassification) (2) Fee: \$9,846 < 20 acres \$10,850 > 20 acres	☑ Tentative Parcel Map (DL) Fee: \$9,888	□ Variance (V) Fee: \$5,036	
☐ General Development Plan (PDG) Fee: \$13,475	Design Review (DR) Commercial Fee: \$9,888 Residential Fee: \$6,097 Signs Fee: \$4,233	City Council Fee: \$1,232	

Universal Application Page 3

Environmental Requirements:

Fee: \$15,845

(STAFF)

M Concurrent Application (2 or more entitlements)

\$2,142 (each add1 50 lots or 100 acres)

☐ Exempt - \$1,277.00

☐ Negative Declaration - \$5,166.00



Mitigated Negative Declaration - \$6,311.00

File Number

☐ Modification to Approved Projects

Fee: \$3,481

rev. 8/17

Universal Application Form (Cont.)

GENERAL PLAN	PROPERTY DATA:	UTILITIES:	
GENERAL PLAN DESIGNATION: Existing: Proposed: Zoning: Existing:PDC Proposed:_PDC	Acres: 93 Square Feet: 40,699 Dimensions: No. of Units:1 Building Size: 3272 Proposed Parking:20	WTILITIES: EXISTING N/A Pub. Sewer N/A Septic Sewer N/A Pub. Water N/A Well Water N/A Electricity N/A Gas N/A Cable	PROPOSED _X Pub. SewerSeptic Sewer _X Pub. WaterWell Water _X ElectricityGasCable
	Required Parking: Access:		

PROJECT REQUEST:
Ouick Quack Car Wash is requesting Design Review, Tentative
Parcel Map and a Use Permit.
Quick Quack Car Wah is Requesting approval of a new 3,272 S.F.
Self Service Car Wash and a 238 S.F. OB Station (Transaction
Building) with 17 Vacuum Stalls, 2 ADA Compliant Parking Stalls
and 1 Parking Stall.

NOTE: Annexations, Lot Line Adjustments, and Rocklin Ranch Industrial Park Specific Plan Use Permits require special application forms and additional submittal information available from the Planning Division.

(Example: Request for approval of design review to construct a 10,000 square foot office building on 1.5 acres)

Universal Application Form (Cont.)

PLEASE PRINT OR TYPE:
NAME OF PROPERTY OWNER: Martin A. Harmon, Trustee of Crosswinds Trust
ADDRESS: 4020 Sierra College Blvd., Suite 200
CITY: Rocklin STATE: CA. ZIP: 95677
PHONE NUMBER: (916)624-6200 Alt. # (916)624-6240
EMAIL ADDRESS: Robv@westerncare.biz
FAX NUMBER: (916) 624-6266
SIGNATURE OF OWNER MARTIN HAR MON MARTIN HAR MON MARTIN HAR MON MARTIN 19-7-(8) (Signature Authorizing Application; provide owner's signature letter if signature is other than property owner.)
NAME OF APPLICANT (If different than owner): Ouick Ouack Developments, LLC.
CONTACT: Efrain Corona
ADDRES 1380 Lead Hill Blvd. Suite 260
CITY: Roseville STATE: CA. ZIP: 95661
PHONE NUMBER: (916) 846-2100
EMAIL ADDRESS: Efrainc@dontdrivedirty.com
FAX NUMBER:
SIGNATURE OF APPLICANT Sphuling

AGENT AUTHORIZATION FORM

Property owners desiring to authorize individuals to represent them in conjunction with any application or matter before the City shall provide written authorization using this form. A separate form shall be used for each individual or firm authorized, and shall specifically note any restrictions upon the authorized person.

Project Name: Quick Quack Car Wash
Location: Sierra College Blvd and Dominguez
Assessors Parcel Number(s): 045-052-026-000
Entitlements for which authorization is applicable (use permit, variance, tentative map, etc.):
Design Review, Tentative Parcel Map and Use Permit
Name of person and / or firm authorized to represent property owner (Please print):
Efrain Corona
Quick Quack Developments, LLC.
Address (Including City, State, and Zip Code):
1380 Lead Hill Blvd. Suite 260
Roseville, CA. 95661
Phone Number: (916) 846-2100
Fax Number: N/A
Email Address: Efrainc@dontdrivedirty.com
The above named person or firm is authorized as:
Agent () Buyer () Lessee (_X)
The above named person or firm is authorized to (check all that are applicable):
(X) File any and all papers in conjunction with the aforementioned request, including signing
the application (X) Speak on behalf of and represent the owner at any Staff meeting and/or public hearing.
(X) Sign any and all papers in my stead, with the exception of the application form.
The duration and validity of this authorization shall be:
(X) Unrestricted () Valid until:
Owners Authorization Signature & Date:
MARTIN HARMON ALLANTRES-7-18
Owners Name (Please Print):
Martin A. Harmon, Trustee of Crosswinds Trust
Owners Address (Including City, State, and Zip Code):
4020 Sierra College Blvd., Suite 200
Rocklin, CA. 95677
Phone Number: (916) 624-6200 & (916) 624-6240
Email Address:



ENVIRONMENTAL INFORMATION SHEET

(To be completed by applicant)

LOCATION OF PROJECT (ADDRESS) Sierra College Blvd. and Dominquez Road
ASSESSORS PARCEL #_ 045-052-026-000
NAME OF PROJECT Quick Quack Car Wash
CONTACT/APPLICANT Efrain Corona Quick Quack Development II, LLC.
ADDRESS 1380 Lead Hill Blvd. Suite 260 Roseville, Ca. 95661
PHONE (916)846-2100 EMAIL Efrainc@dontdrivedirty.com
Project Description - Describe in detail. Add separate sheet if necessary.
Construction pf a fully Automated Car Wash to include Pay Canopy,
Vacuum Canopies, Vacuum Enclosure, Trash Enclosure and Wash Tunnel.
Property size: 40,699 Square Feet Acres Land Use: Vacant Lot Self Service Car Wash Existing Proposed
RELATED PROJECTS: If this project is a part or portion of a larger project, describe the previous project by name, general development plan number, or other project identification. Secret Ravine Apartments (Under Separate Submittal/Design)
PREVIOUS ENVIRONMENTAL DOCUMENTS: If this project is part of a larger project for which a negative declaration or an environmental impact report has been prepared and certified, reference the document below. Include the date and SCH#, if possible: Secret Ravine Community Environmental Documents Available if Needed
DTHER REQUIRED PERMITS OR APPROVALS: Permit or Approval Agency Address Contact Person/Phone Unknown
PREVIOUS LAND USES: Describe existing and previous land uses of the site for the last 10 years or nore: Vacant Lot

SITE CHARACTERISTICS

1.	What natural features (trees, rock outcroppings etc.) presently exist on the site? It is considered a Foothill Woodland and Annual Grassland Area.
2.	What are the surrounding land uses? Planned Dev. Planned Dev. Planned Dev. Planned Dev. Planned Dev. Planned Dev. Commercial North Commercial South
3.	Is the project proposed on land which contains fill or a slope of 10% or more?_No
4.	Are there any existing erosion problems?_No
5.	Is the site on expansive soils (as defined in Table 18 of the UBC) or immediately adjoining an area subject to slides, liquefaction, slope instability or other related hazards? If so, describe in detail, or refer to attached soils report. Please See Attached Soils Report
6.	Grading, excavating or filling activities - Quantity of cubic yards to be: a. Moved within the site N/A Completed by Developer b. Deposited on the site N/A Completed by Developer c. Removed from the site N/A Completed by Developer
7.	Disposal site Are there any streams or permanent water courses on the site?No Describe
8.	Will the proposed project change drainage patterns or the quality of groundwater? If so explain. If not, why not. No, not hydrologically connected to any water source.
9.	Will the project affect any drainage channel, creek, pond or any other water body? Describe below: No

10.	Is any portion of the property located in a flood plain? No If so describe
11.	Are there any jurisdictional wetlands or vernal pools on the site? If so how will they be impacted by the project? No
12.	Are there any trees or shrubs on the project site? Yes What types? Valley Oaks, Interior Live Oak, Blue Oak, Foothill Pine Are any to be removed or transplanted? Removed State the location of transplant site: N/A State the number & species to be removed: Please See Report
13.	
14.	Will the project result in any new noise source, or will it place new residents in an area of high traffic noise or noise from any other source? Yes
15.	What type of equipment will be associated with the project during construction? Small Back Hoe, Bulldozer, Hand Tools, Compressor, etc
	During permanent operation? Vacuum
16.	Describe any air pollutants, other than vehicle exhaust, which would be generated by this project, both during and after construction. Dust particulates are considered pollutants. None
17.	Will the project produce new sources of dust, ash, smoke, fumes or objectionable odor? If yes, describe the source of the emission, methods to control emissions and means of mitigating those effects on adjacent properties: No
18.	Will the project create any new light source, other than street lighting? If yes, describe below: <u>Building and Site Lights</u>
19.	Is this property covered by a Williamson Act contract? No
20.	Has this property ever been used for agricultural purposes?_NoIf so, for what purpose and when?
21.	Does the project involve the use of routine transport or disposal of hazardous materials? No
22.	Are there any known mineral resources of value to the region and the residents of the state located on the site? If so, what types? NO
23.	How close is the nearest school? 1,210 Feet

Height of other appurtenances (antennas, steeples, mechanical equipment, etc.) measured from ground: N/A Project site coverage: Building 3510	24.	Size of new structure	(s) or addition ured from grou	in gross squar	ESIDENTIAL AND NON-R re feet: 3510 point in feet: 29 Feet	ESIDENTIAL)	
from ground: N/A Project site coverage: Building 3510 sq.ft. 9 % Landscaping 8,620 sq.ft. 21 % Paving 28,569 sq.ft. 70 % Exterior building materials: Stucco & CMU Exterior building colors: Beige and Brown Wall and/or fencing material: N/A Total number of off-street parking spaces required: N/A Provided: 20 Total Total number of bicycle parking spaces: 3 25. Is there any exposed mechanical equipment associated with the project? No Location and screening method 26. RESIDENTIAL PROJECTS Total lots N/A Total dwelling units N/A Density/acre N/A Total acreageN/A Single Two Multi-Family Number of Units Size of lot/unit				ennas, steeples	s, mechanical equipment,	etc.) measured	
Landscaping 8,620 sq.ft. 21 % Paving 28,569 sq.ft. 70 % Exterior building materials: Stucco & CMU Exterior building colors: Beige and Brown Wall and/or fencing material: N/A Total number of off-street parking spaces required: N/A Provided: 20 Total Total number of bicycle parking spaces: 3 25. Is there any exposed mechanical equipment associated with the project? No Location and screening method 26. RESIDENTIAL PROJECTS Total lots N/A Total dwelling units N/A Density/acre N/A Total acreageN/A Single Two Multi-Family (More than 2 units) Number of Units Size of lot/unit		from ground: N/A					
Paving 28,569 sq.ft.70 % Exterior building materials: Stucco & CMU Exterior building colors: Beige and Brown Wall and/or fencing material: N/A Total number of off-street parking spaces required: N/A Total number of bicycle parking spaces: 3 25. Is there any exposed mechanical equipment associated with the project? No Location and screening method 26. RESIDENTIAL PROJECTS Total lots N/A Density/acre N/A Single Two Multi-Family Family Family (More than 2 units) Number of Units Size of lot/unit		Project site coverage:				%	
Exterior building materials: Stucco & CMU Exterior building colors: Beige and Brown Wall and/or fencing material: N/A Total number of off-street parking spaces required: N/A Provided: 20 Total Total number of bicycle parking spaces: 3 25. Is there any exposed mechanical equipment associated with the project? No Location and screening method 26. RESIDENTIAL PROJECTS Total lots N/A Total dwelling units N/A Density/acre N/A Total acreageN/A							
Exterior building colors: Beige and Brown Wall and/or fencing material: N/A Total number of off-street parking spaces required: N/A Total number of bicycle parking spaces: 3 25. Is there any exposed mechanical equipment associated with the project? No Location and screening method 26. RESIDENTIAL PROJECTS Total lots N/A Density/acre N/A Total acreageN/A Single Two Multi-Family (More than 2 units) Number of Units Size of lot/unit		Extension building and			sq.ft. <u>70</u>	%	
Wall and/or fencing material:N/A Total number of off-street parking spaces required:N/A Provided:20Total Total number of bicycle parking spaces:3							
Total number of off-street parking spaces required: N/A Provided: 20 Total Total number of bicycle parking spaces: 3 25. Is there any exposed mechanical equipment associated with the project? No Location and screening method 26. RESIDENTIAL PROJECTS Total lots N/A Total dwelling units N/A Density/acre N/A Total acreageN/A Single Two Multi-Family (More than 2 units) Number of Units Size of lot/unit		Wall and/or foncing m	s: <u>Beige ar</u>	nd Brown			
25. Is there any exposed mechanical equipment associated with the project? No Location and screening method 26. RESIDENTIAL PROJECTS Total lots N/A Density/acre N/A Single Family Single Family Number of Units Size of lot/unit		Total number of off-ct	reet parking s	nacos roquirod	Laria Duaridad		
25. Is there any exposed mechanical equipment associated with the project? No Location and screening method 26. RESIDENTIAL PROJECTS Total lots N/A Total dwelling units N/A Density/acre N/A Total acreageN/A Single Two Multi-Family (More than 2 units) Number of Units Size of lot/unit		Total number of bicyc	le narking spa	paces required	- <u>N/A</u> Provided	<u>20 Total</u>	
26. RESIDENTIAL PROJECTS Total lots N/A Total dwelling units N/A Density/acre N/A Total acreageN/A Single Two Multi-Family (More than 2 units) Number of Units Size of lot/unit		rotal Hamber of Bicyc	ic parking spar				
26. RESIDENTIAL PROJECTS Total lots N/A Total dwelling units N/A Density/acre N/A Total acreageN/A Single Two Multi-Family (More than 2 units) Number of Units Size of lot/unit	25.	Is there any exposed m	echanical equi	pment associat	ted with the project? No		
26. RESIDENTIAL PROJECTS Total lots N/A		Location and screening	g method		iou man and project.		
Total lots N/A Total dwelling units N/A Density/acre N/A Total acreage N/A Single Two Multi-Family (More than 2 units) Number of Units Size of lot/unit							
Density/acre_N/A Total acreageN/A Single Two Multi-Family (More than 2 units) Number of Units Size of lot/unit	26.						
Single Two Multi-Family Family Family (More than 2 units) Number of Units Size of lot/unit							
Family Family (More than 2 units) Number of Units Size of lot/unit		Density/acre_N/A	Total ac	reage <u>N/A</u>			
Family Family (More than 2 units) Number of Units Size of lot/unit			Cin alla	T -			
Number of Units Size of lot/unit				1	Multi-Family		
Number of Units Size of lot/unit			ramily	Family			
		Number of Units			diffico)		
Ctudio		Size of lot/unit					
		Studio					
1 Bedroom		1 Bedroom					
2 Bedroom		2 Bedroom					
3 Bedroom							
4+ Bedroom		4+ Bedroom					
27. RETAIL, COMMERCIAL, INDUSTRIAL, INSTITUTIONAL OR OTHER PROJECT	2/.	RETAIL, COMMERCIAL, I	NDUSTRIAL, I	NSTITUTIONA	L OR OTHER PROJECT		
Type of use(s): Self Service Car Wash		Type of use(s): Self	Service Ca				
Oriented to: RegionalCity Neighborhood		Uniented to: Regional_	00 7 00 /	City	Neighborhood		
Hours of operation: 7:00-7:00 (Winter Months) 7:00-9:00 (Summer Months)							
		Total occupancy/Building capacity:					
				Fundament of	richiffu 2 Number		
Number of visitors/customers on site at busiest time (best estimate): 25		Number of employees (total): 3 - 6 Employees per shift: 2 Number of Shifts 3					
Other occupants (specify): N/A		Silvinger of Visitors/Cus		מר המאבאר מוווונ	t (best estimate): <u>45</u>		

ALL PROJECTS

28. Approximately how many tons of solid waste will the project produce each year? $\underline{\text{Less than 1}}$ ton

29.	Will the proposed use involve any toxic or hazardous material? No Is the project site within 2,000 feet of an identified hazardous/toxic site? No Is the project site within 2,000 feet of a school or hospital? Yes If the project involves any hazardous material, explain: N/A
30.	How many new residents is the project estimated to generate? None
31.	Will the project generate a demand for additional housing?No
32.	What is the current and estimated number of motor vehicles to arrive at the site as a result of the project?
33.	Could the project increase traffic hazards to motor vehicles, bicyclists or pedestrians? Yes If yes, explain Additional Traffic
34.	How close is the project to the nearest public park or recreation area? 3 miles
35.	What school districts will be affected by this project? None
36.	Describe energy-efficient features included in the project. Recycled Water, Drip Irrigation System and Controller and Led Lighting
37.	Describe how the following services or utilities will be provided: Power and Natural Gas N/A Telephone_Underground Water_Underground Sewer_Underground Storm Drainage_Underground Solid Waste_Trash_Enclosure Waste_Management
38.	Will the project block any vista or view currently enjoyed by the public?No
39.	Are there any known historic or significant building features on or near the site? If so, will the project result in any impact to the building? $_{\rm NO}$
40.	Are there any archaeological features on the site? <u>Unknown</u> If so, will the project result in any impact to these features?













РНОТО 6










РНОТО 8



PHOTO 21



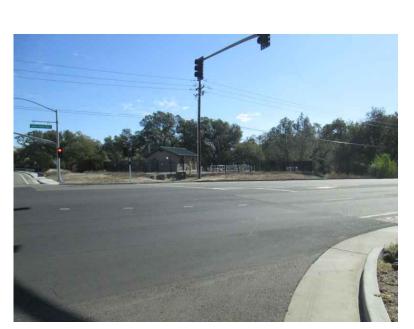

РНОТО 9



РНОТО Ю

PHOTO II





PH0T0 19

РНОТО 18













QUICK QUACK CARWASH 1380 LEAD HILL BLVD #260 ROSEVILLE CA 95661 (916) 846-2100

PROJECT NAME:

QUICK QUACK CARWASH

SIERRA COLLEGE

ROCKLIN, CA. 95677

QQ# 6-021

DRAWING TITLE:


SITE PHOTOS


DRAWING DATE: SEPTEMBER 29, 2017

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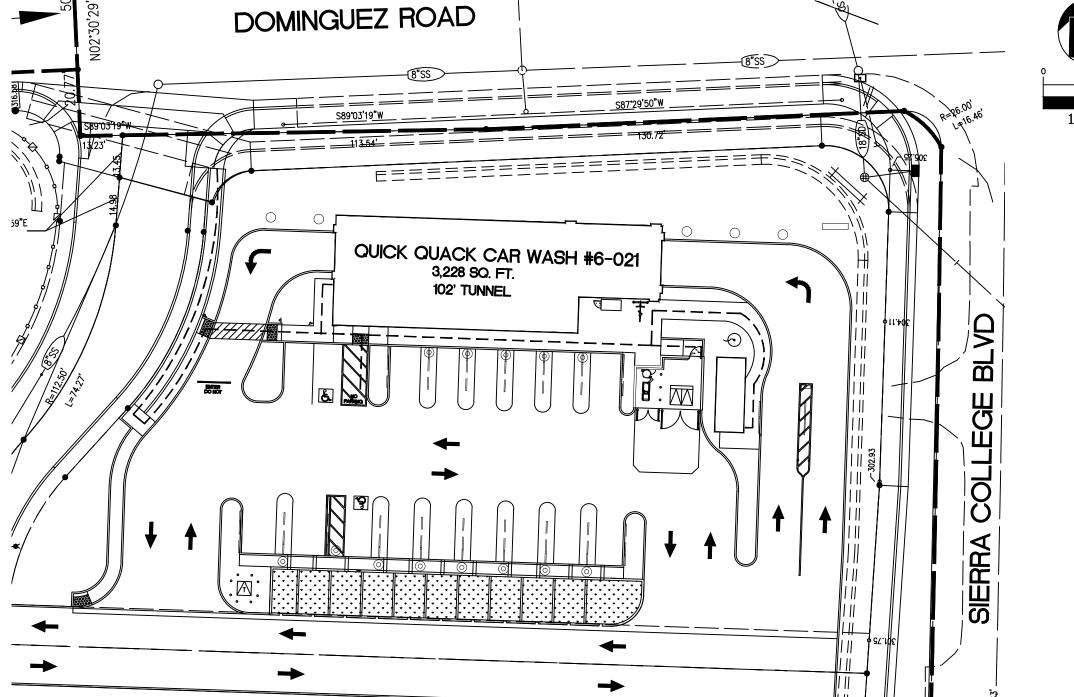


PH0T0 15 PHOTO 14 PHOTO B PH0T0 17 PH0T0 16 PHOTO 12



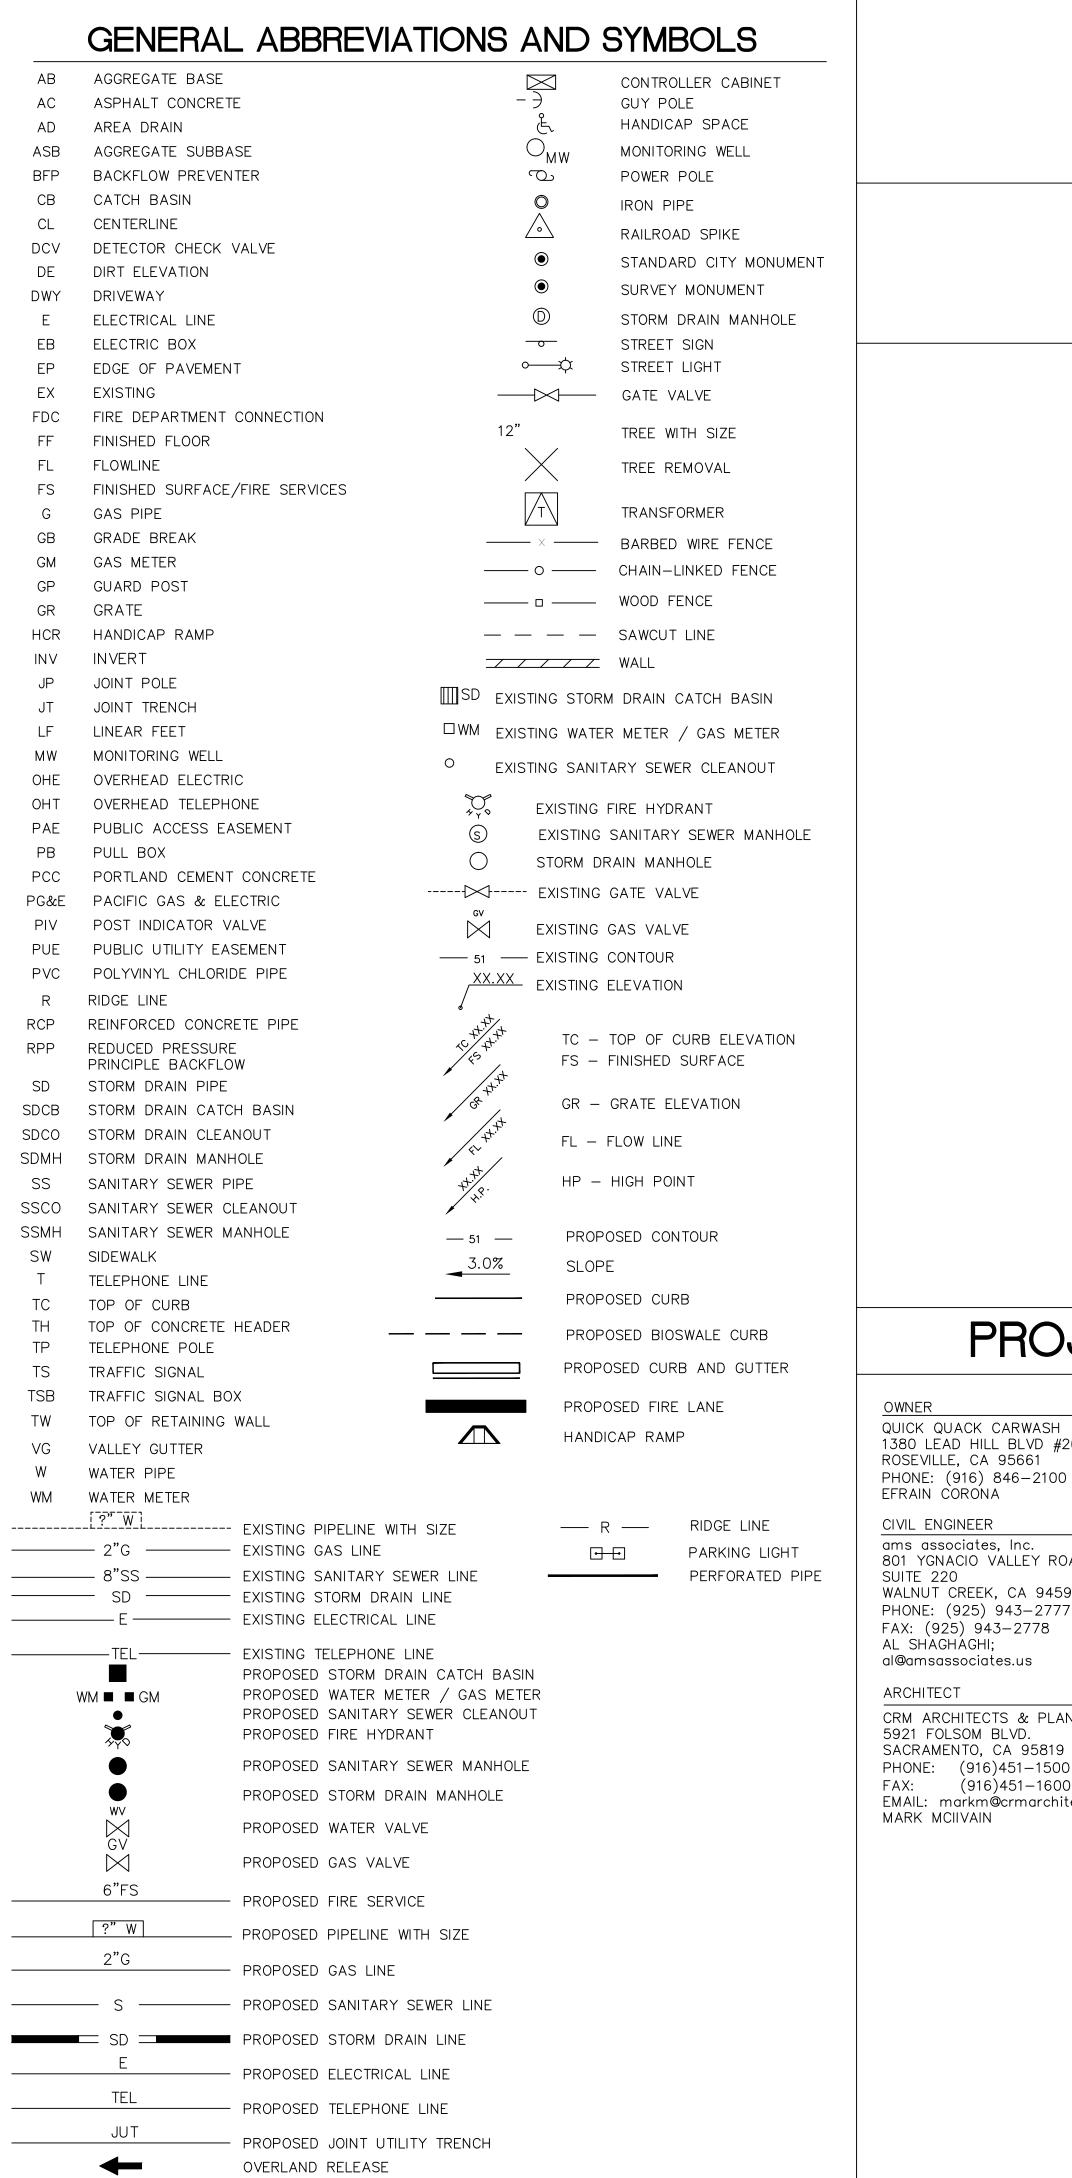

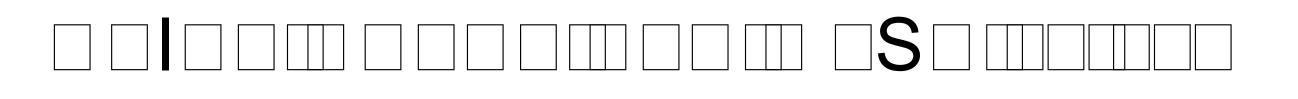SIE



PROJECT CONTACTS

QUICK QUACK CARWASH 1380 LEAD HILL BLVD #260

EFRAIN CORONA

CIVIL ENGINEER ams associates, Inc. 801 YGNACIO VALLEY ROAD, SUITE 220 WALNUT CREEK, CA 94596 PHONE: (925) 943-2777

ARCHITECT

CRM ARCHITECTS & PLANNERS, INC. 5921 FOLSOM BLVD. SACRAMENTO, CA 95819 PHONE: (916)451-1500 (916)451-1600 EMAIL: markm@crmarchitects.com MARK MCIIVAIN

CITY OF ROCKLIN

DEPARTMENT OF PLANNING DARA DUNGWORTH - ASSOCIATE PLANNER 3970 ROCKLIN ROAD ROCKLIN, CA 95677 916-625-5160

DARA.DUNGWORTH@ROCKLIN.CA.US

CITY OF ROCKLIN DEPARTMENT OF PUBLIC WORKS

4081 ALVIS CT. ROCKLIN, CA 95677 916-625-5500

GAS AND ELECTRICITY PACIFIC GAS & ELECTRIC (PG&E)

3301 INDUSTRIAL AVE. ROCKLIN, CA 95765 916-408-3210

SOUTH PLACER MUNICIPAL UTILITY DISTRICT (SPMUD)

MS. CARY HUFF 5807 SPRINGVIEW DR. ROCKLIN, CA 95677

SOLID WASTE REMOVAL

RECOLOGY AUBURN PLACER 12305 SHALE RIDGE LANE AUBURN, CA 95602 530-885-3735

WATER COMPANY

SANITARY SEWER

PLACER COUNTY WATER AGENCY MR. JOSH LELKO 144 FERGUSON RD. AUBURN, CA 95603 530-823-4886

PROJECT DATA

045-052-026-000

BASIS OF BEARINGS: THE BEARING OF NORTH 01°55'52" EAST TAKEN ON THE CENTERLINE OF SIERRA COLLEGE BOULEVARD AS SHOWN ON THAT CERTAIN RECORD OF SURVEY FILED FOR RECORD ON AUGUST 17, 2015 IN BOOK 22 OF SURVEYS AT PAGE 139, PLACER COUNTY RECORDS WAS TAKEN AS THE BASIS OF ALL BEARINGS SHOWN HEREON.

BENCHMARK:

A.P.N.:

CITY OF ROCKLIN BENCHMARK "R 3-4": FOUND USGS BRASK DISK STAMPED "J1200 RESET" LOCATED IN A GRANITE ROCK OUTCROPPING, APPROXIMATELY 10 FEET EAST OF A CHAIN LINK FENCE ON THE NORTHERLY SIDE OF ROCKLIN ROAD, EASTERLY OF THE RAILROAD TRACKS. ELEVATION: 259.5 FEET (VERTCON) (DATUM) NAVD 1988

FLOOD ZONE NOTE:

THE SUBJECT PROPERTY IS SHOWN ON THE FEDERAL EMERGENCY MANAGEMENT AGENCY FLOOD INSURANCE RATE MAP, COMMUNITY PANEL NUMBER 060239 0418 F, DATED JUNE 08, 1998, AS BEING LOCATED IN FLOOD ZONE "X";

AREAS OF DETERMINED TO BE OUTSIDE THE 0.2% ANNUAL CHANCE FLOOD.


INFORMATION WAS OBTAINED FROM THE FEMA WEBSITE (WWW.FEMA.GOV) ON SEPTEMBER 08, 2017.

SOILS ENGINEER

DATE:

THIS GRADING PLAN HAS BEEN REVIEWED BY THE UNDERSIGNED AND FOUND TO BE IN CONFORMANCE WITH THE RECOMMENDATIONS AS OUTLINED IN THE PROJECTS SOILS REPORT DATED ______ (FILE NO.: _____). THIS SOILS REPORT AND SUPPLEMENTAL LETTER SHALL BE CONSIDERED AS PART OF THIS PLAN AND ALL GRADING WORK SHALL BE IN ACCORDANCE WITH SAID SOILS REPORT AND SUPPLEMENTAL LETTER. WE MAKE NO REPRESENTATION AS TO THE ACCURACY OF DIMENSIONS, MEASUREMENTS, CALCULATIONS, OR ANY PORTION OF THE DESIGN.

RM:		
Y:		

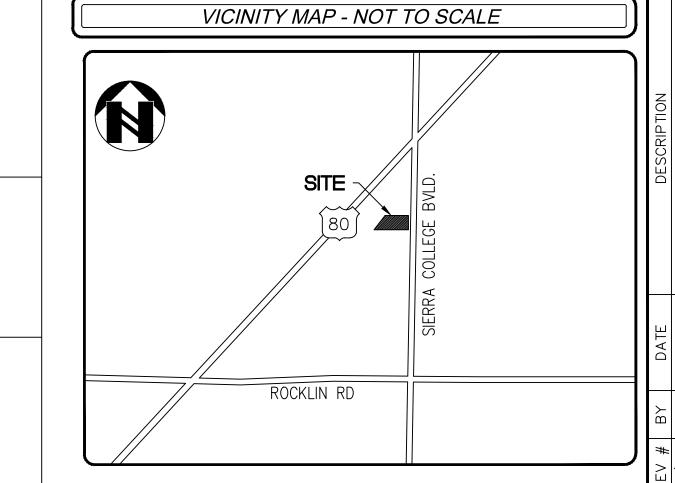

SHEET INDEX

ONSITE CIVIL PLANS

C-5.1


COVER SHEET HORIZONTAL CONTROL PLAN C-2.1C-3.1 **GRADING PLAN** C-4.1UTILITY PLAN


STORMWATER CONTROL PLAN


CITY OF ROCKLIN ENGINEERING DEPARTMENT	
APPROVED BY:	
CITY ENGINEER	DATE
CITY OF ROCKLIN FIRE DEPARTMENT	
APPROVED BY:	
FIRE CHIEF	DATE
DEPARTMENT OF PUBLIC	SERVICES
APPROVED BY:	
DIRECTOR	DATE
SOILS REPORT	
COMPANY NAME:	
JOB NUMBER	DATE
PLACER COUNTY WATER	AGENCY
APPROVED BY:	
ENGINEER	DATE
SPMUD	
APPROVED BY:	
ENGINEER	DATE
BUILDING DEPARTMENT P	ERMITS


DEFERRED SUBMITTAL REQUIRED TO BUILDING DEPARTMENT FOR:




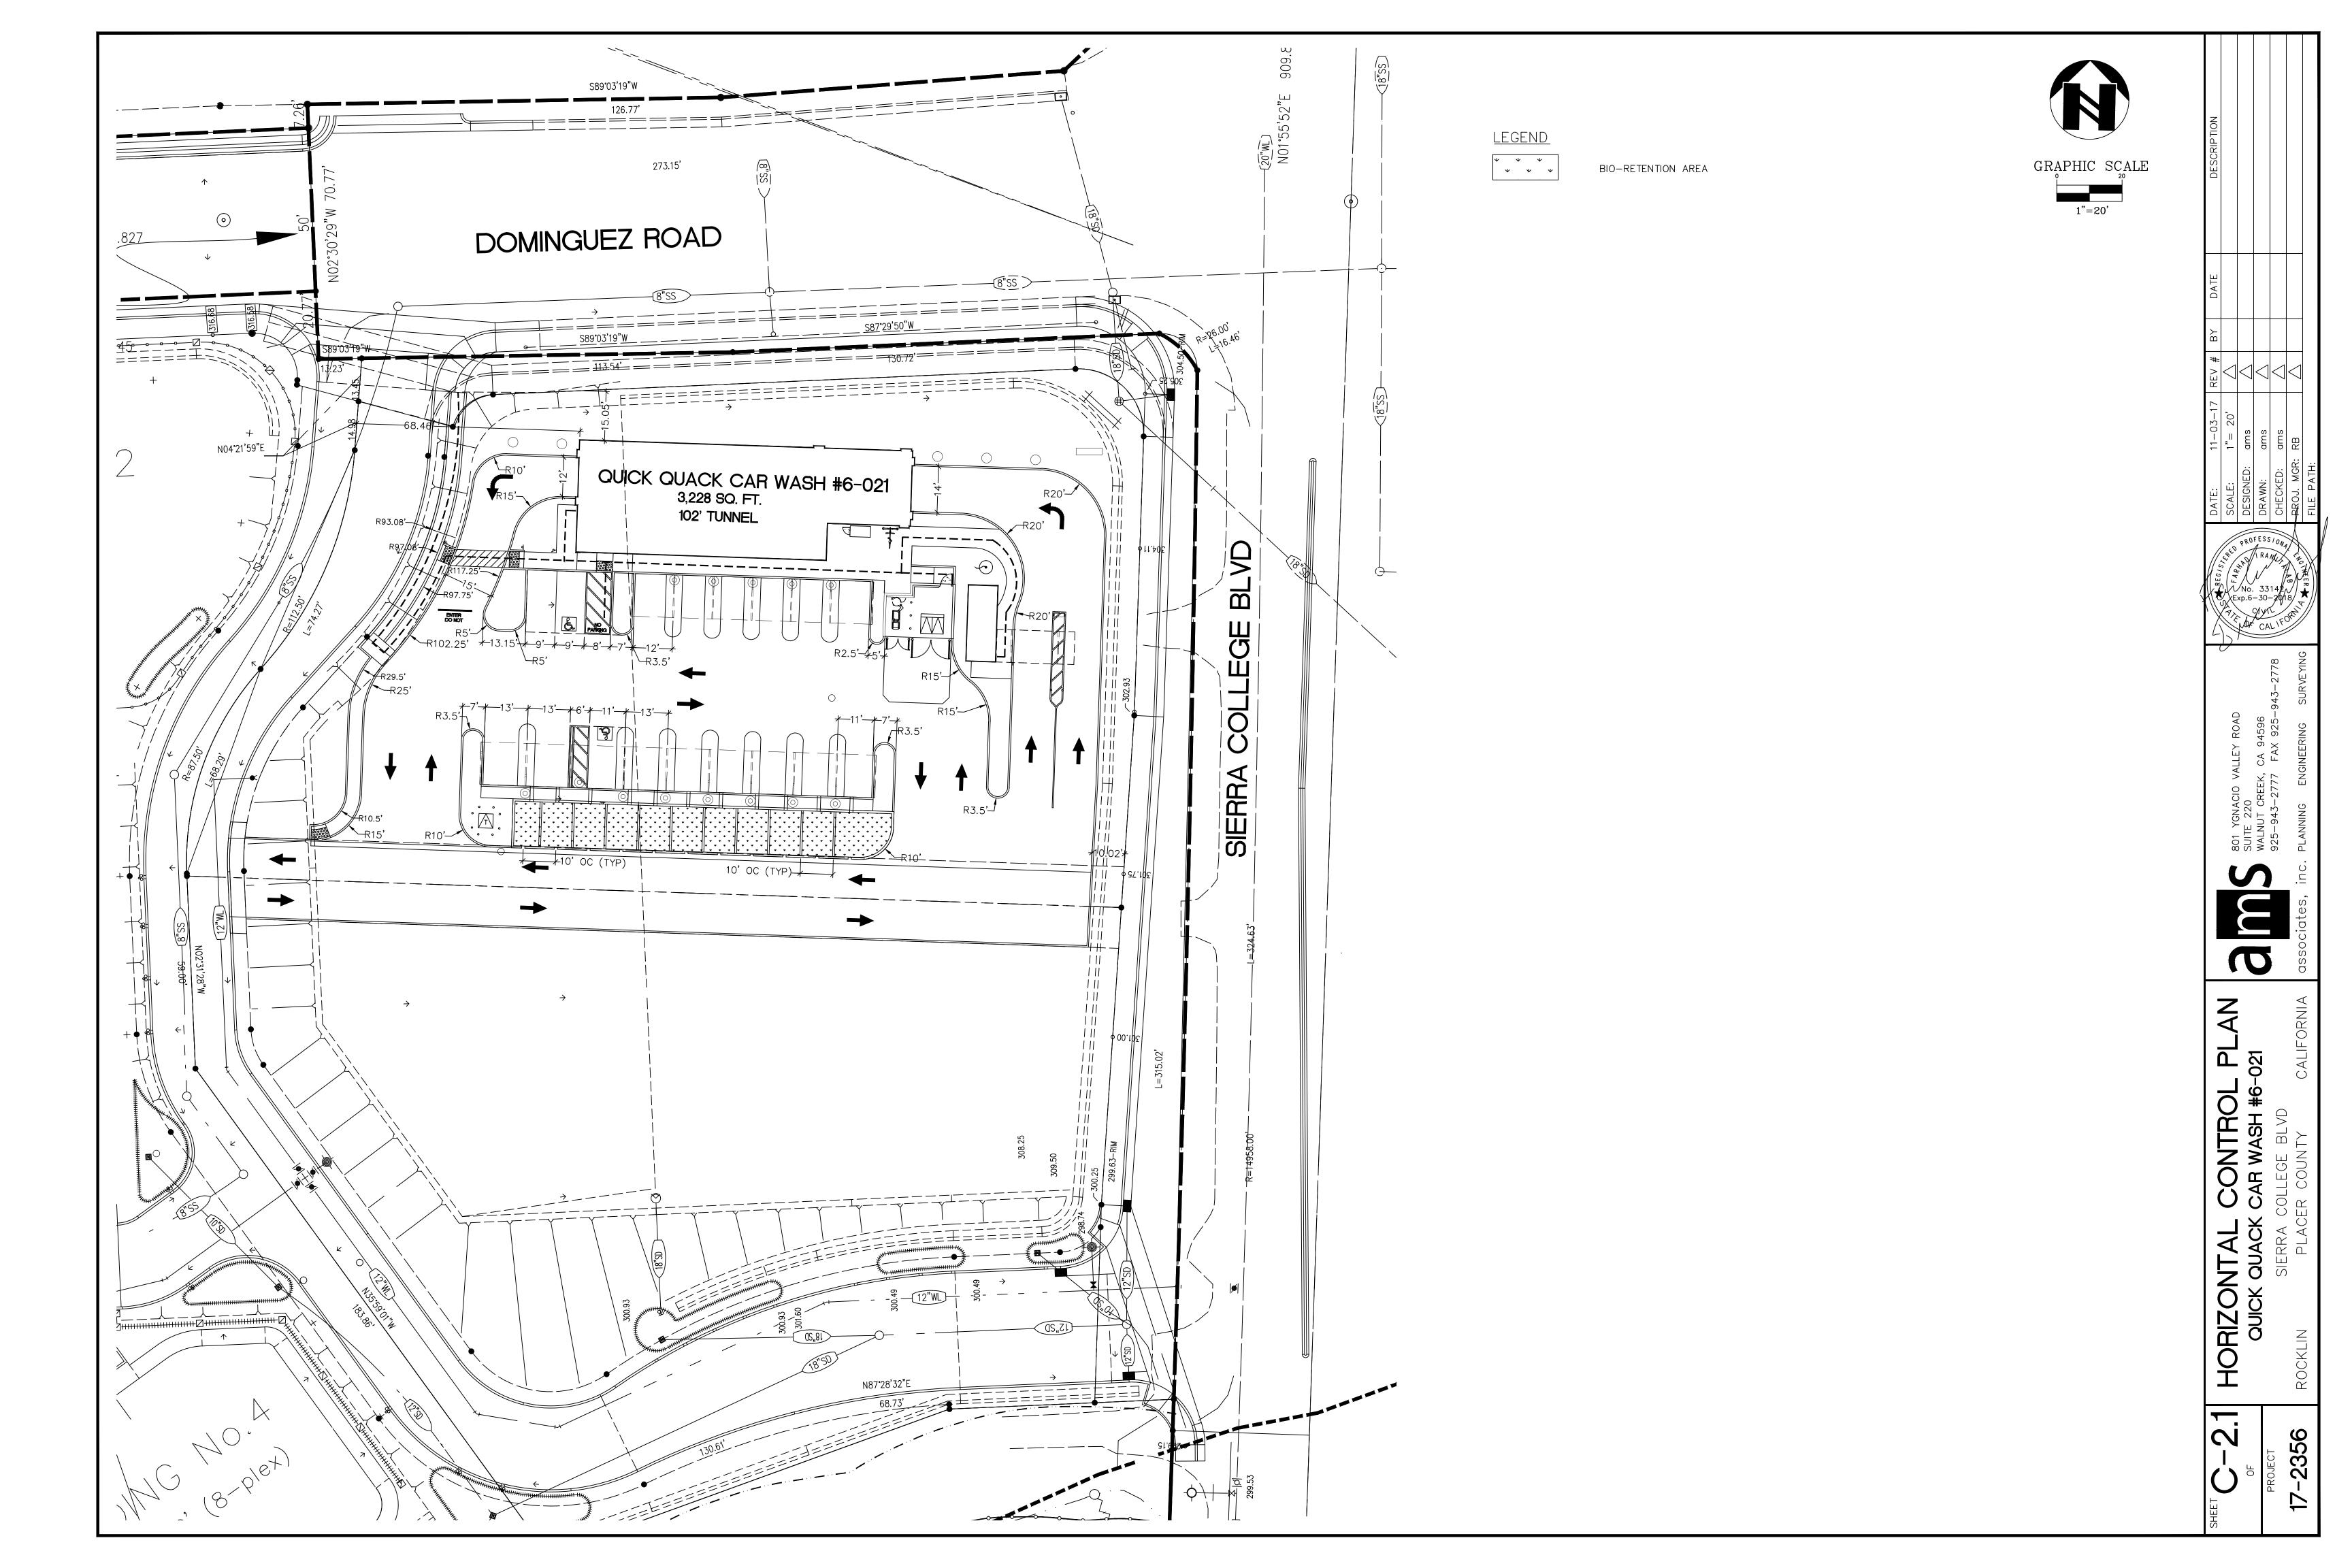

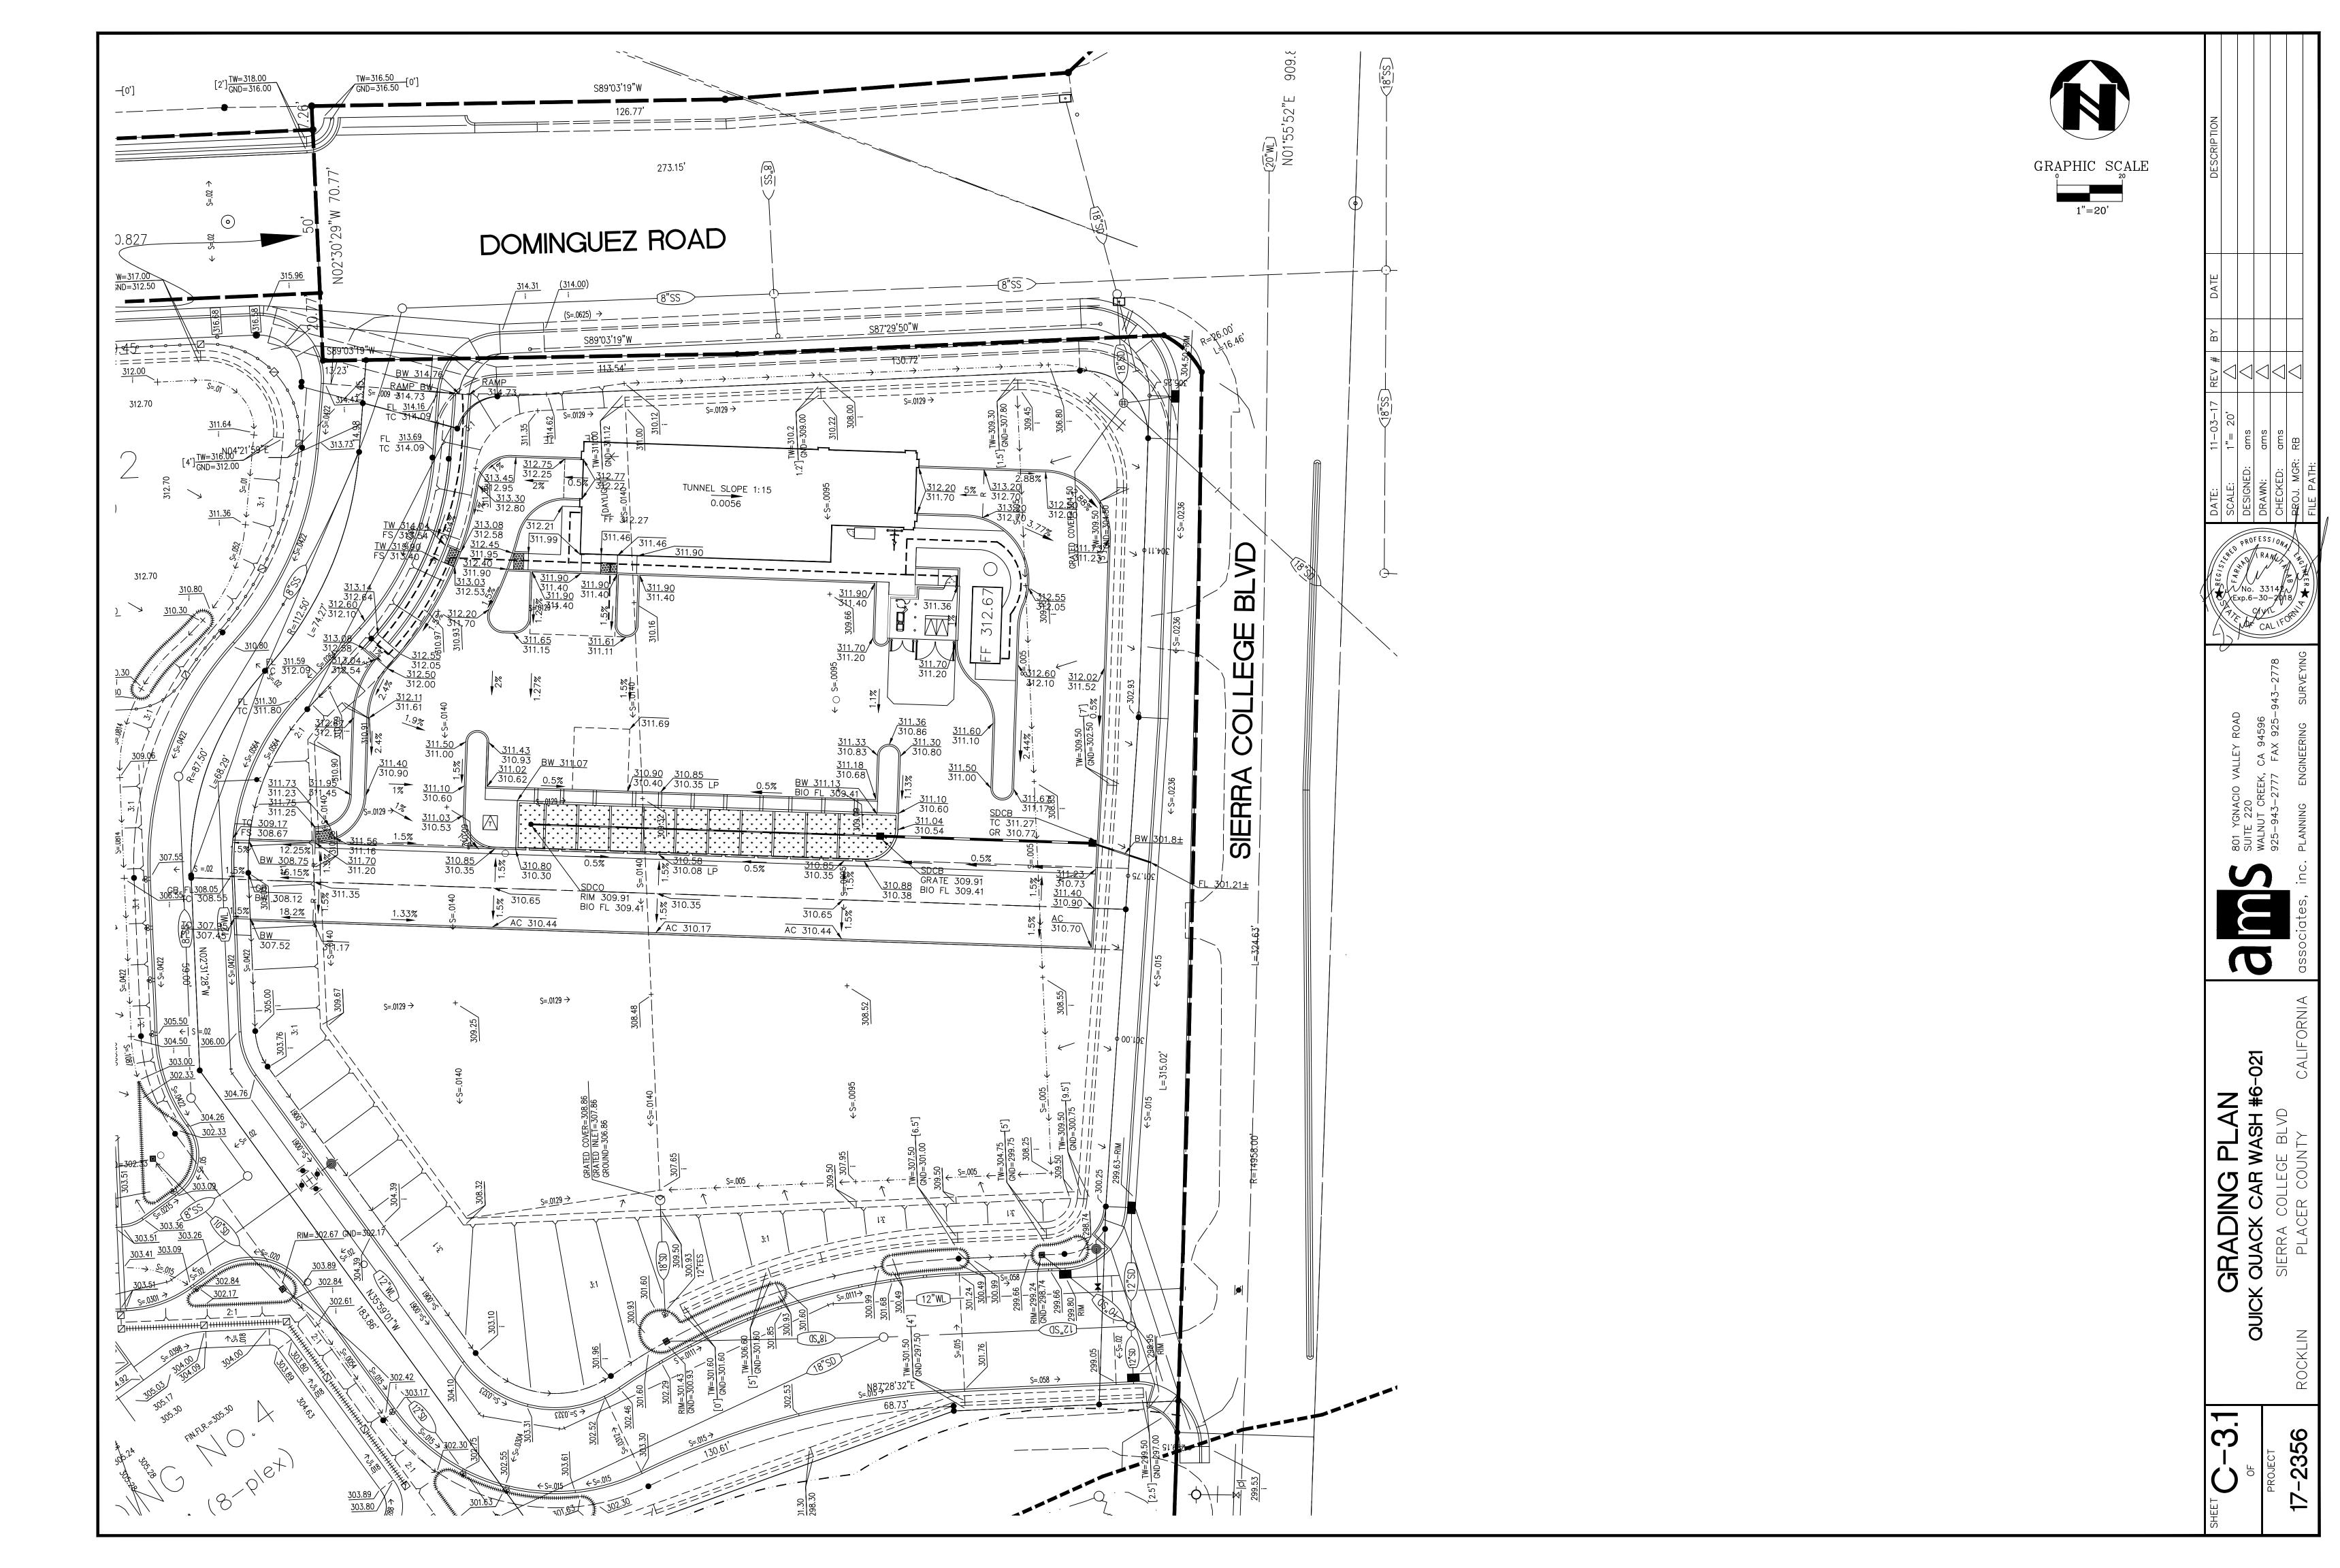

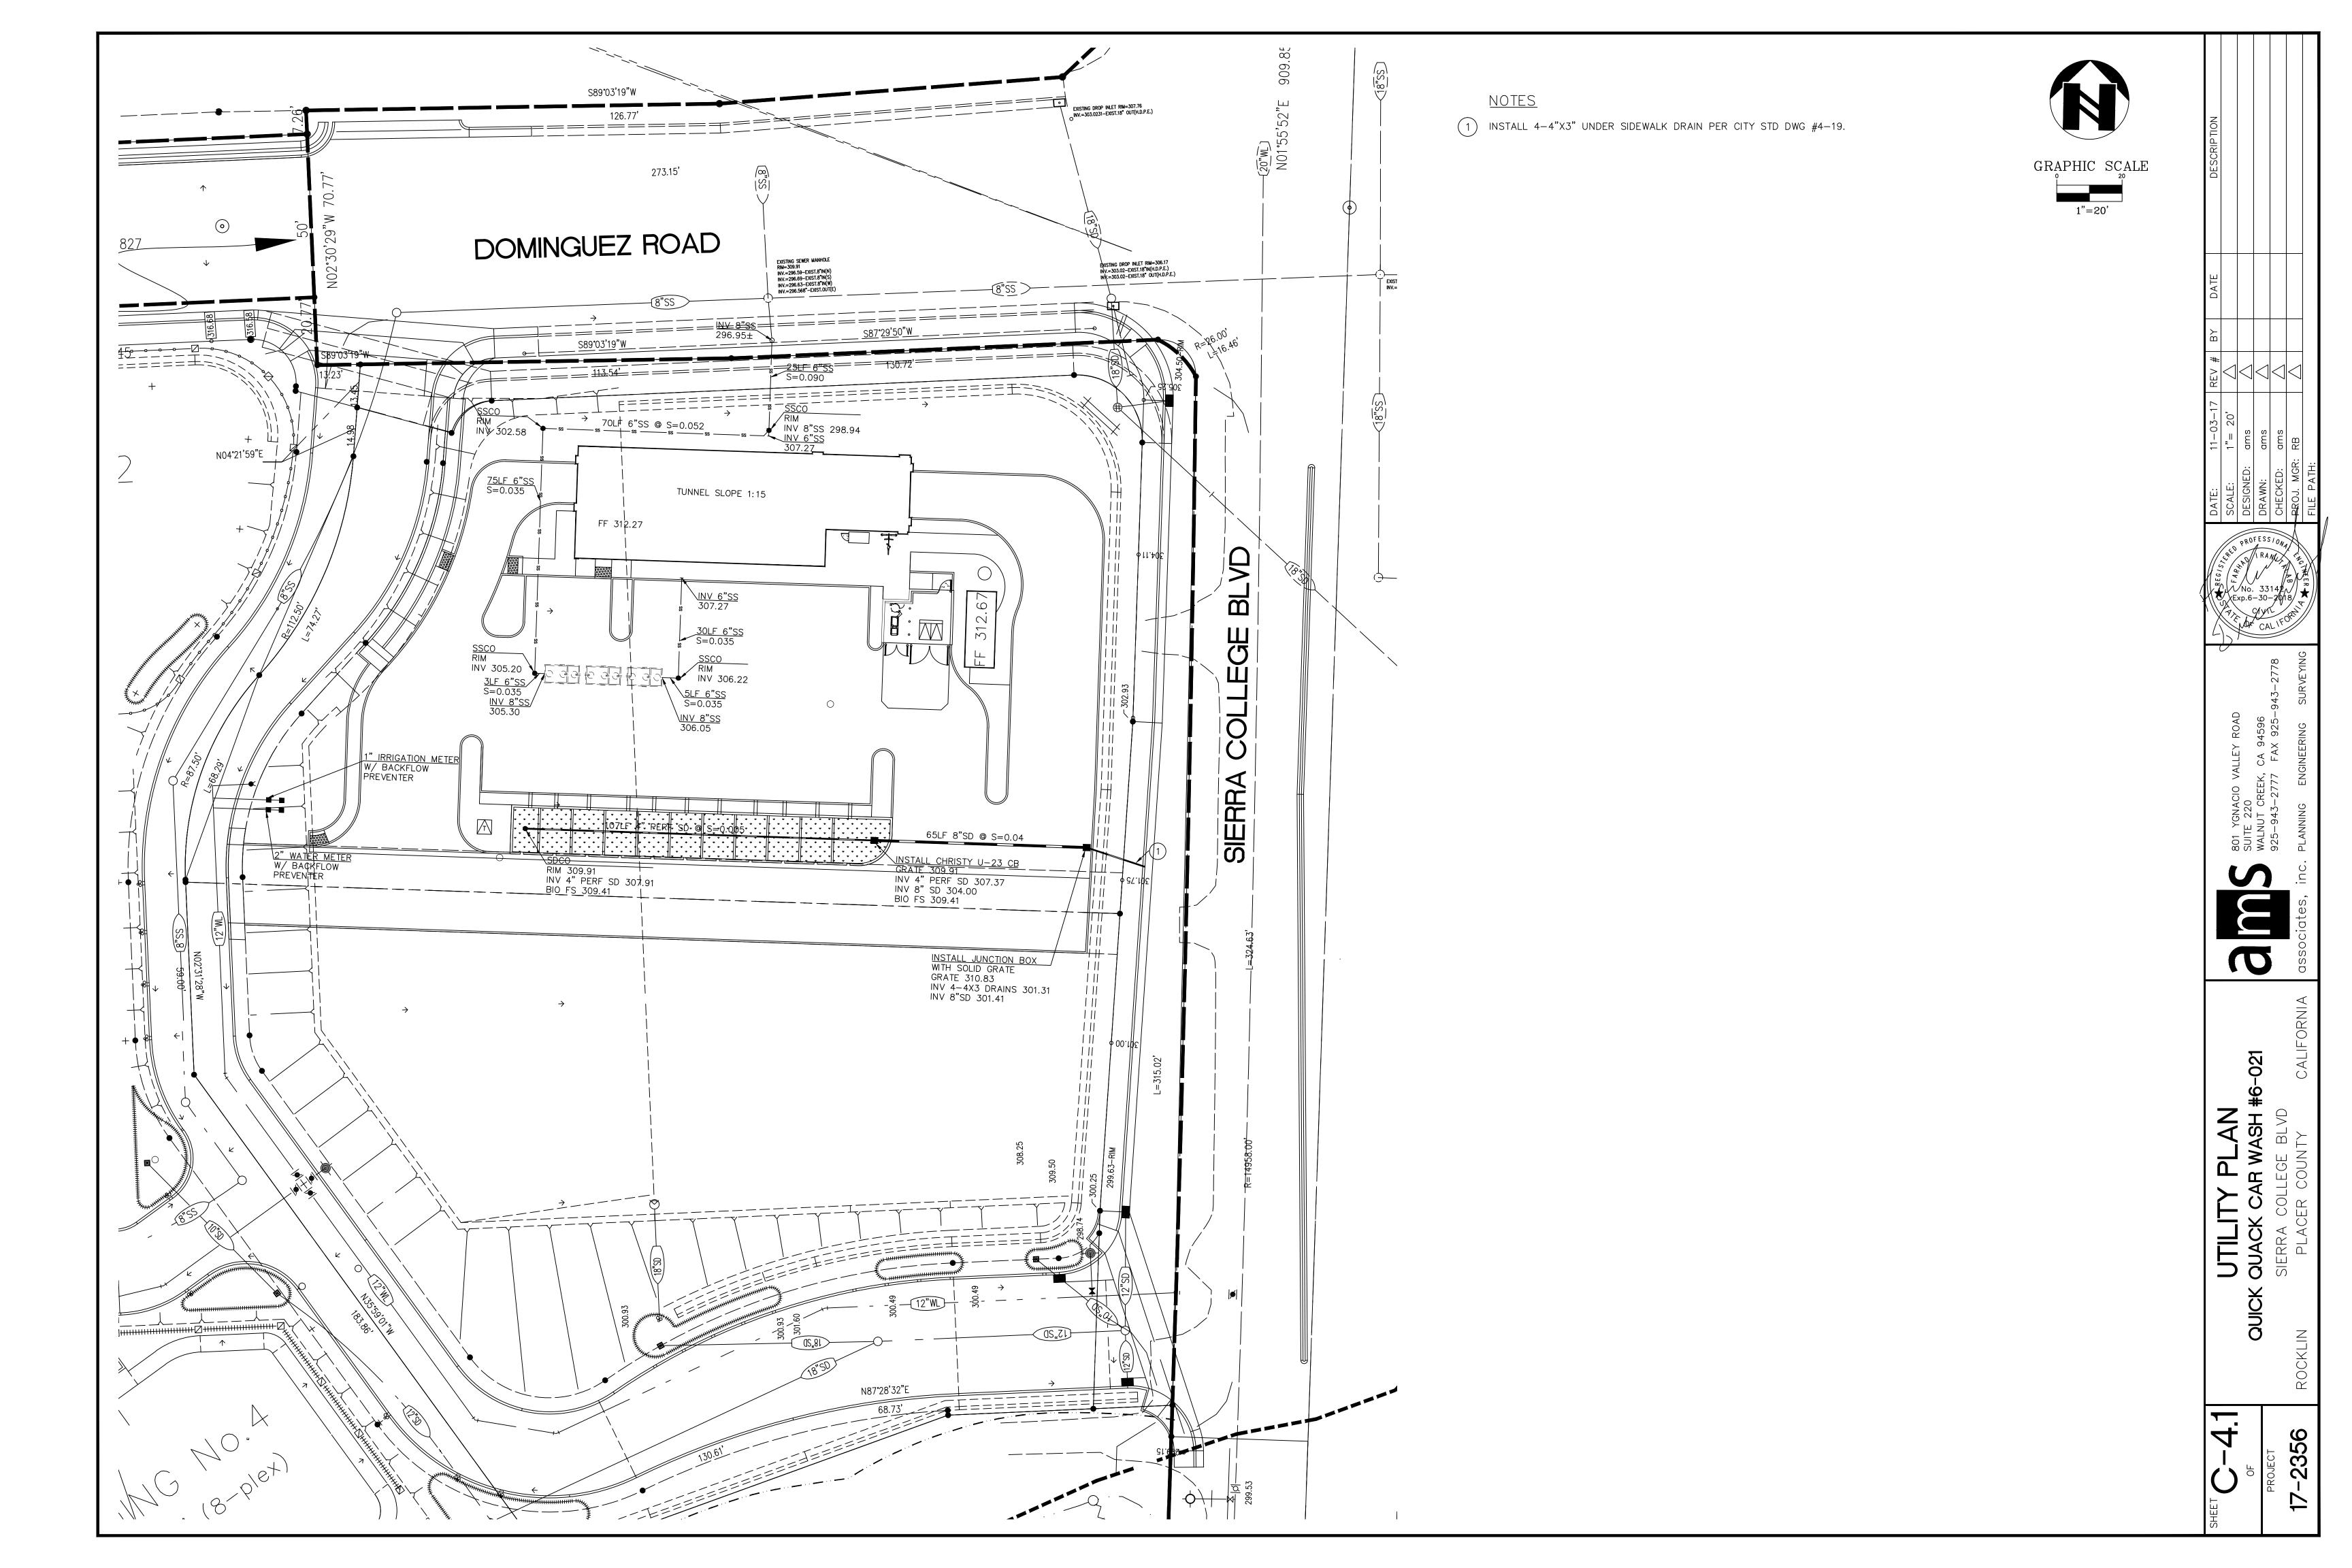


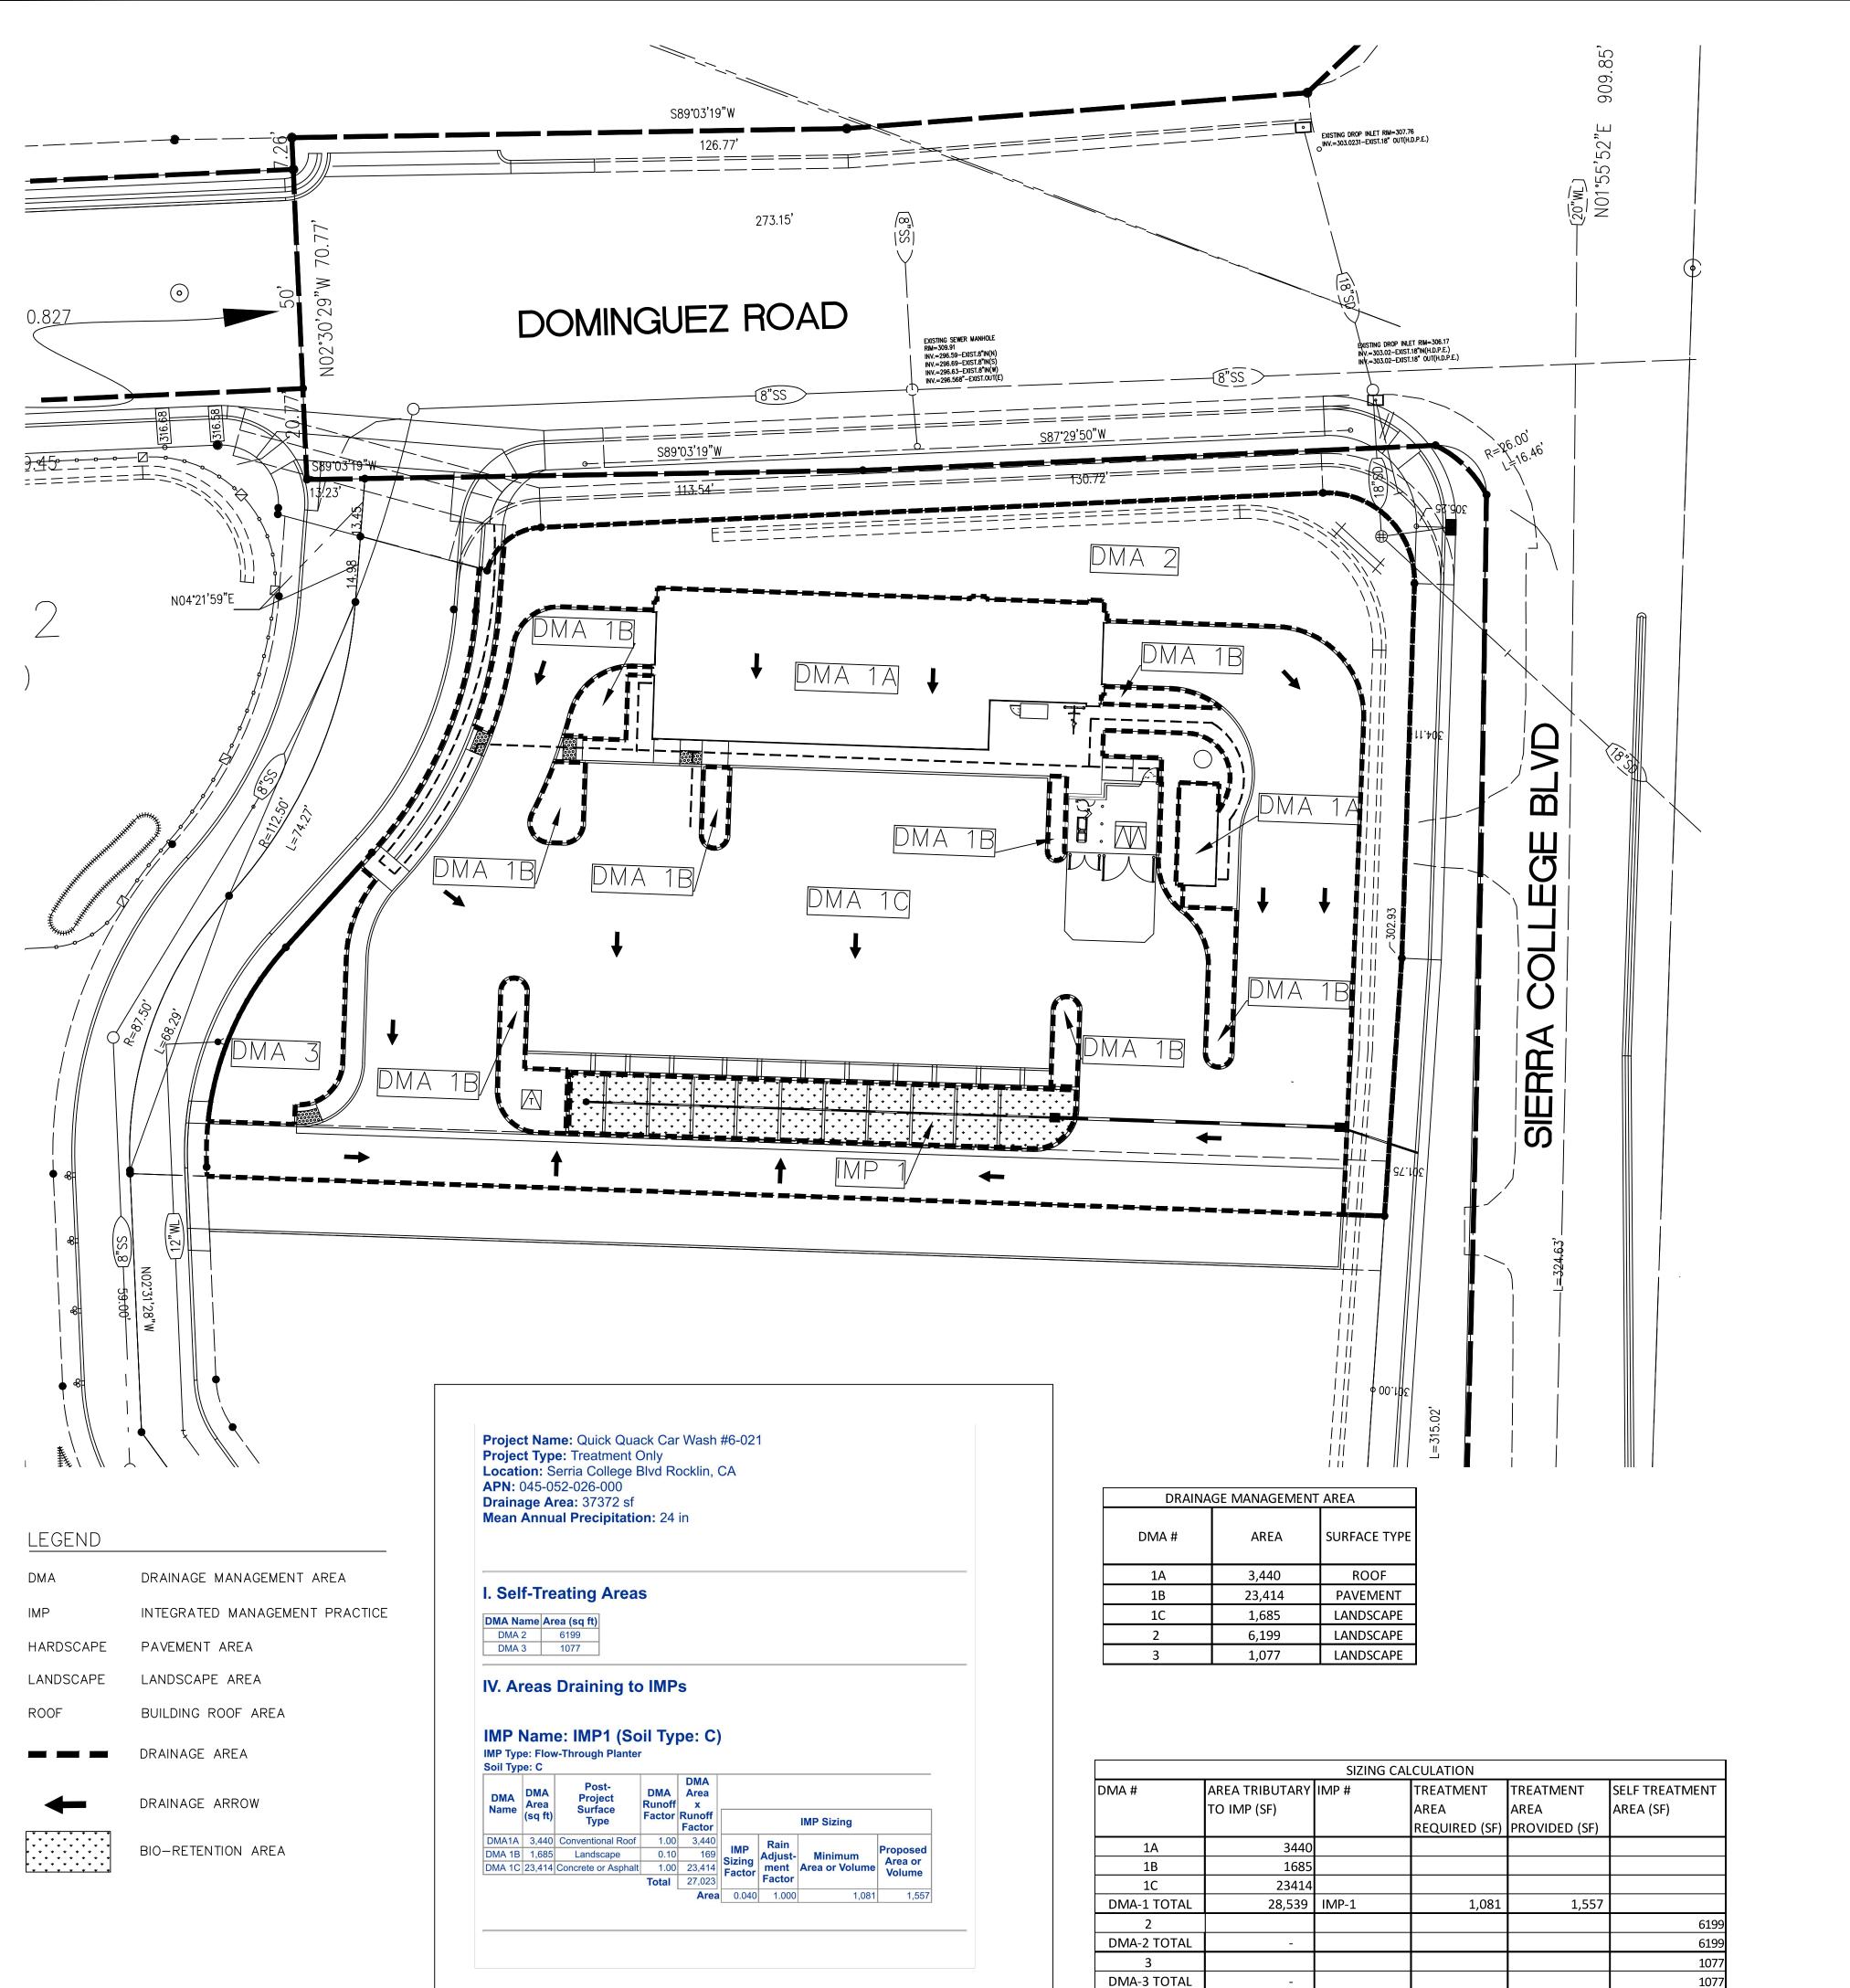

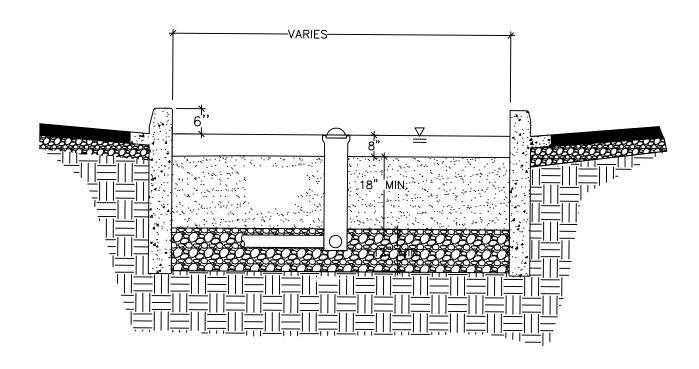





- 1. SCARIFY SUBGRADE BEFORE INSTALLING BIORETENTION AREA AGGREGATE AND BSM.
- 2. FACILITY EXCAVATION TO ALLOW FOR SPECIFIED SOIL AND MULCH DEPTHS TO ACHIEVE FINISHED ELEVATIONS ON CIVIL PLANS.
- 3. INSTALL UNDERDRAIN WITH HOLES FACING DOWN. UNDERDRAIN DISCHARGE ELEVATION SHALL BE NEAR TOP OF AGGREGATE LAYER. UNDERDRAIN SLOPE MAY BE FLAT.
- 4. DO NOT WORK WITHIN BIORETENTION AREA DURING RAIN OR UNDER WET CONDITIONS.
- 5. KEEP HEAVY MACHINERY OUTSIDE BIORETENTION AREA LIMITS.
- 6. ALL MULCH IN BIORETENTION CELLS SHOULD BE 2—3 INCHES OF COMPOSTED, NON—FLOATABLE MATERIAL IN AREAS BETWEEN PLANTINGS.

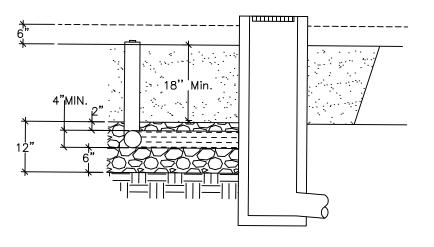

- 1. NO LINER, NO FILTER FABRIC, NO LANDSCAPE CLOTH BETWEEN BSM AND AGGREGATE.
- 2. MAINTAIN BGL. TGL, TSL THROUGHOUT FACILITY AREA AT ELEVATIONS TO BE SPECIFIED IN PLAN.
- 3. CLASS 2 PERMEABLE MATERIAL LAYER MAY EXTEND BELOW AND UNDERNEATH INLET.
- 4. ELEVATION OF UNDERDRAIN DISCHARGE IS AT TOP OF GRAVEL LAYER.

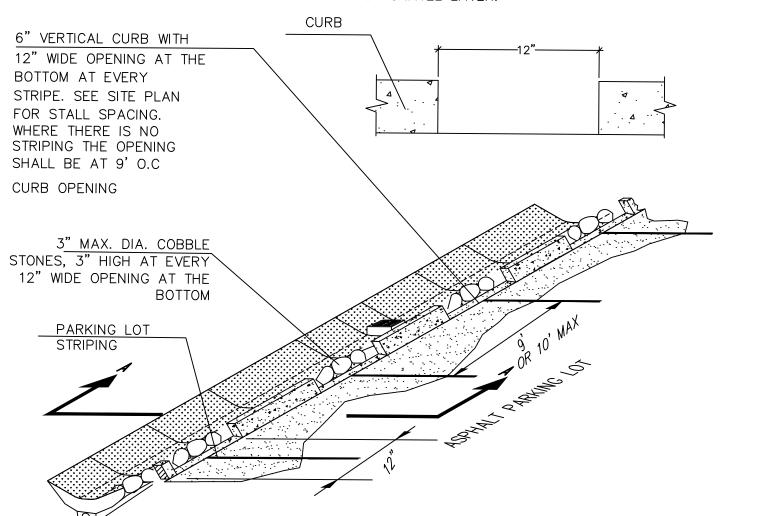

ORMWATER QUICK QUACK C

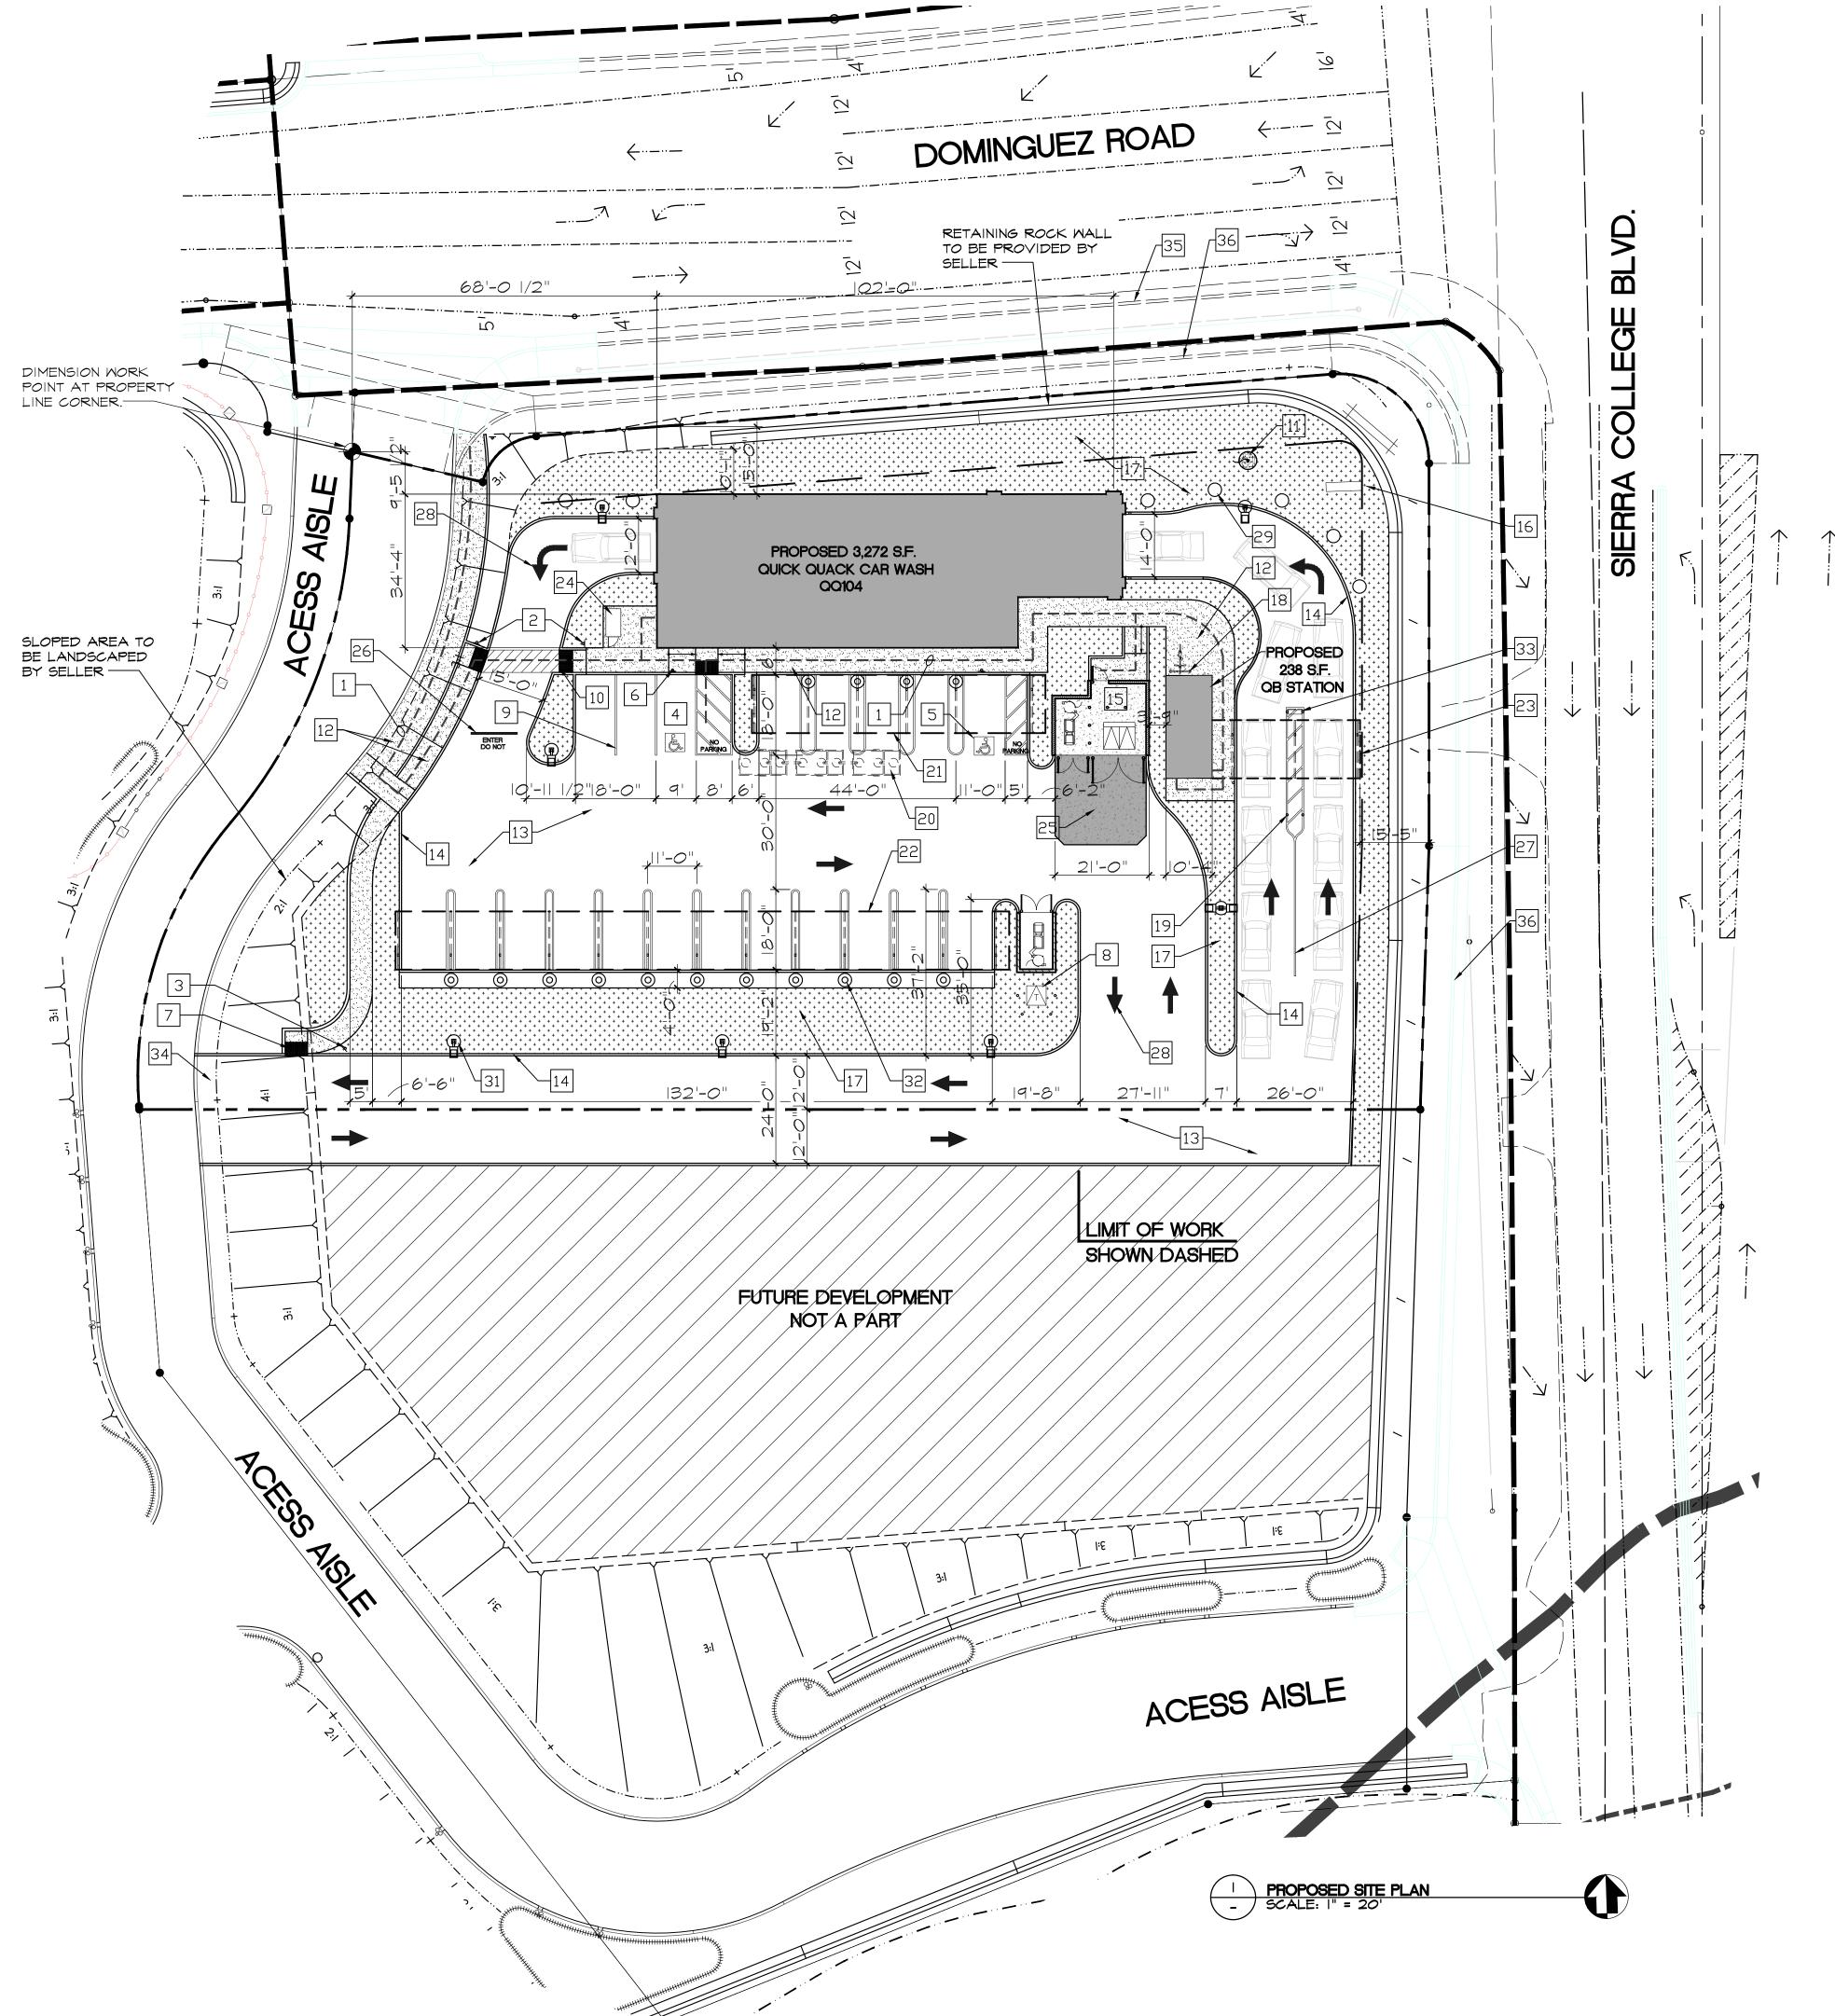

<u>KEYNOTES</u>

- 1 ADA PATH OF TRAVEL SHOWN DASHED.
- 2 NEW POLE MOUNTED INTERNATIONAL SYMBOL OF ACCESSIBILITY AT ACCESSIBLE PATH OF TRAVEL. (TYPICAL 4 PLACES)
- 3 NEW TOW AWAY ACCESSIBILITY PARKING SIGN
- 4 NEW VAN ACCESSIBLE PARKING STALL PAINT ACCESSIBLE LOADING ZONE WITH 4" WIDE STRIPING WITH TWO COATS OF HIGHWAY BLUE PAVEMENT MARKING PAINT. PAINT THE WORDS "NO PARKING" IN 12" HIGH LETTERS WITHIN THE LOADING ZONE.
- 5 NEW INTERNATIONAL SYMBOL AT PARKING STALL (TYP. 2 PLACES)
- 6 NEW ACCESSIBLE PARKING SIGN. (TYPICAL 2 PLACES)
- 7 NEW TRUNCATED DOMES (TYPICAL 4 PLACES)
- 8 NEW ELECTRICAL TRANSFORMER. EXACT LOCATION AND NUMBER OF PIPE BOLLARDS TO BE DETERMINED BY ELECTRIC COMPANY
- 9 NEW PARKING STRIPING PER CITY OF ROCKLIN STANDARDS (TYP.)
- 10 NEW FLUSH SURFACE AT TRANSITION (TYPICAL)
- 11 30 FOOT FLAG POLE. STYLE: "MEMORIAL" UNCOMMON USA, INC. INSTALL PER MANUFACTURER'S INSTALLATION GUIDELINES.
- NEW 4" THICK CONCRETE WALK, MEDIUM BROOM FINISH PERPENDICULAR TO PATH OF TRAVEL. SLOPE NOT TO EXCEED 5% IN DIRECTION OF TRAVEL. CROSS SLOPE NOT TO EXCEED 2%.
- 13 NEW 5" MINIMUM THICK MINIMUM CONCRETE DRIVE SLAB WITH WITH #4 BARS AT MID SLAB 24" O.C. EACH WAY. HEAVY BROOM FINISH PERPENDICULAR TO TRAFFIC
- 14 NEW 6" CONCRETE CURB (TYPICAL)
- 15 NEW EQUIPMENT AND TRASH ENCLOSURE
- 16 NEW MONUMENT SIGN- SEE SIGN DRAWINGS
- 17 NEW LANDSCAPING SEE LANDSCAPE DRAWINGS
- 18 NEW BICYCLE RACK
- 19 NEW 6" CONCRETE FILLED PIPE BOLLARD (TYPICAL II PLACES)
- 20 NEW UNDERGROUND GREASE INTERCEPTOR
- 21 NEW 13'-0" X 65'-7" VACUUM CANOPY SEE CANOPY DRAWINGS
- 22 NEW 13'-0" X 137'-7" VACUUM CANOPY SEE CANOPY DRAWINGS
- 23 NEW 13'-0" X 33'-7" PAY CANOPY SEE CANOPY DRAWINGS
- 24 NEW LONG TERM BICYCLE LOCKER
- NEW 8" THICK MINIMUM CONCRETE DRIVE SLAB WITH W/ #4 BARS AT MID SLAB 24" O.C. EACH WAY. HEAVY BROOM FINISH PERPENDICULAR TO TRAFFIC
- 26 NEW HIGHWAY PAINT WHITE 18" "DO NOT ENTER"
- 27 NEW HIGHWAY PAINT WHITE 4" STRIPING
- 28 NEW HIGHWAY PAINT WHITE PAVEMENT MARKINGS (TYPICAL)
- 29 NEW TOMMY BALL SPHERICAL BOLLARD LOCATED IN PLANTER. (TYPICAL 5 PLACES)
- 30 NEW RAMP WITH HANDRAILS SEE CIVIL DRAIMNGS
- 31 NEW 20' HIGH LED SITE LIGHTS (TYPICAL 7 PLACES)
- 32 NEW TRASH RECEPTACLES (TYPICAL 13 PLACES)
- 33 NEW DISPLAY SIGN. SEE SIGN PLANS
- 34 NEW 24'-0" WIDE DRIVEWAY PER PUBLIC WORKS REQUIREMENTS
- 35 EXISTING PUBLIC CONCRETE CURB, AND GUTTER TO REMAIN
- 36 FUTURE PUBLIC CONCRETE CURB, SIDEWALK AND GUTTER

SITE NUMBER: 6-021

BUILDING: QQ-104 SEPARATE QB STATION

SITE AREA: .93 ACRE - 40,699 S.F.

STACKING LANES: 2 LANES

STACKING WIDTH: 13'-0"

VACUUM STALLS: 17 - 11'-0" × 18'-0"

VACUUM PRODUCER: 2 - 50HP

ADA PARKING: | - 9'-0" × 18'-0"

PARKING STALLS: 2 - 9'-0" × 18'-0"

BUILDING AREA: 3,318 S.F. + 237 S.F. = 3,555 S.F.
BUILDING SPRINKLED: NO

OB STATION ATTACHED: NO
BUILDING LENGTH: 104'-0"
SHOWROOM LENGTH: 102'-0"
CONVEYOR TRENCH LENGTH: 102'-0"

CONVEYOR TYPE: REAR WHEEL PUSH

CONVEYOR LENGTH: |O|'-2"

SIGNATURE:_

APPROVAL DATE:

PROJECT DATA

EXISTING USE: VACANT LAND PROPOSED USE: CAR WASH A.P.N.: 045-052-026 ZONING: PD-C DISTRICT: COLLEGE PROPOSED SITE AREA: 40,699 S.F ACRE: .93 ACRE LANDSCAPING AREA: 8620 S.F. LANDSCAPING %: 21% PROPOSED CAR WASH AREA: 3,510 S.F. MAXIMUM AREA ALLOWED: 5,000 S.F 29'-0" MAXIMUM HEIGHT ALLOWED: 40 FEET CONSTRUCTION TYPE VΒ

CONSTRUCTION TYPE:

OCCUPANCY:

SPRINKLERS

NO

STORIES:

I STORY



VICINITY MAP



OWNER -



QUICK QUACK CARWASH 1380 LEAD HILL BLVD #260 ROSEVILLE CA 95661 (916) 846-2100

PROJECT NAME: QUICK QUA

QUICK QUACK CARWASH SIERRA COLLEGE ROCKLIN, CA. 95677 QQ# 6-021

DRAWING TITLE:

PROPOSED SITE PLAN

DRAWING DATE: SEPTEMBER 29, 2017

PLANNING DOCUMENTS

DRAWING NUMBER

A2.0

Symbol	Qty	Label	Arrangement	Lumens/Lamp	LLF	Lum. Watts	Description
ı	4	F1	SINGLE	4584	1.000	66	FLD-OL-SN-D2-14-E-UL-SV-700
	5	F10	WALL MOUNT	2722	0.990	25	XSPW-A-0-3-M-G-U-x
•	19	F11	SINGLE	5000	1.000	51	WS4-50L-50K-10V-FD-SSL
	18	F9_8	LFL 8FT	N.A.	1.000	70	LFL-A-8-DO-UL-SV-53K-SA
·	6	SF1	SINGLE	17291	1.000	130	OSQ-A-NM-4ME-K-57K-UL-xx
	1	SF2b	BACK-BACK	17291	1.000	130	OSQ-A-NM-4ME-K-57K-UL-xx
	7	T1	SINGLE	N.A.	1.000	30	RS-30WLED-DO-xx-120

Calculation Summary
Label

Avg/Min 21.60 Max/Min Pavement

FIXTURE MOUNTING HEIGHTS AS SHOWN POLES MOUNTED ON 2' CONCRETE BASE

ADDITIONAL EQUIPMENT REQUIRED:


(7) CL-SSP-4011-18-D5-xx (16' x 4" SQUARE POLE, 3@90° MOUNT) (8) OSQ-DAxx DIRECT ARM MOUNT

(19) WS4MBK WS4 MOUNTING BRACKET WIND LOADS

PROPOSED POLES MEET SUSTAINED WIND LOADS

***CUSTOMER TO VERIFY MOUNTING, VOLTAGE, AND COLOR

PRIOR TO PLACING ORDER

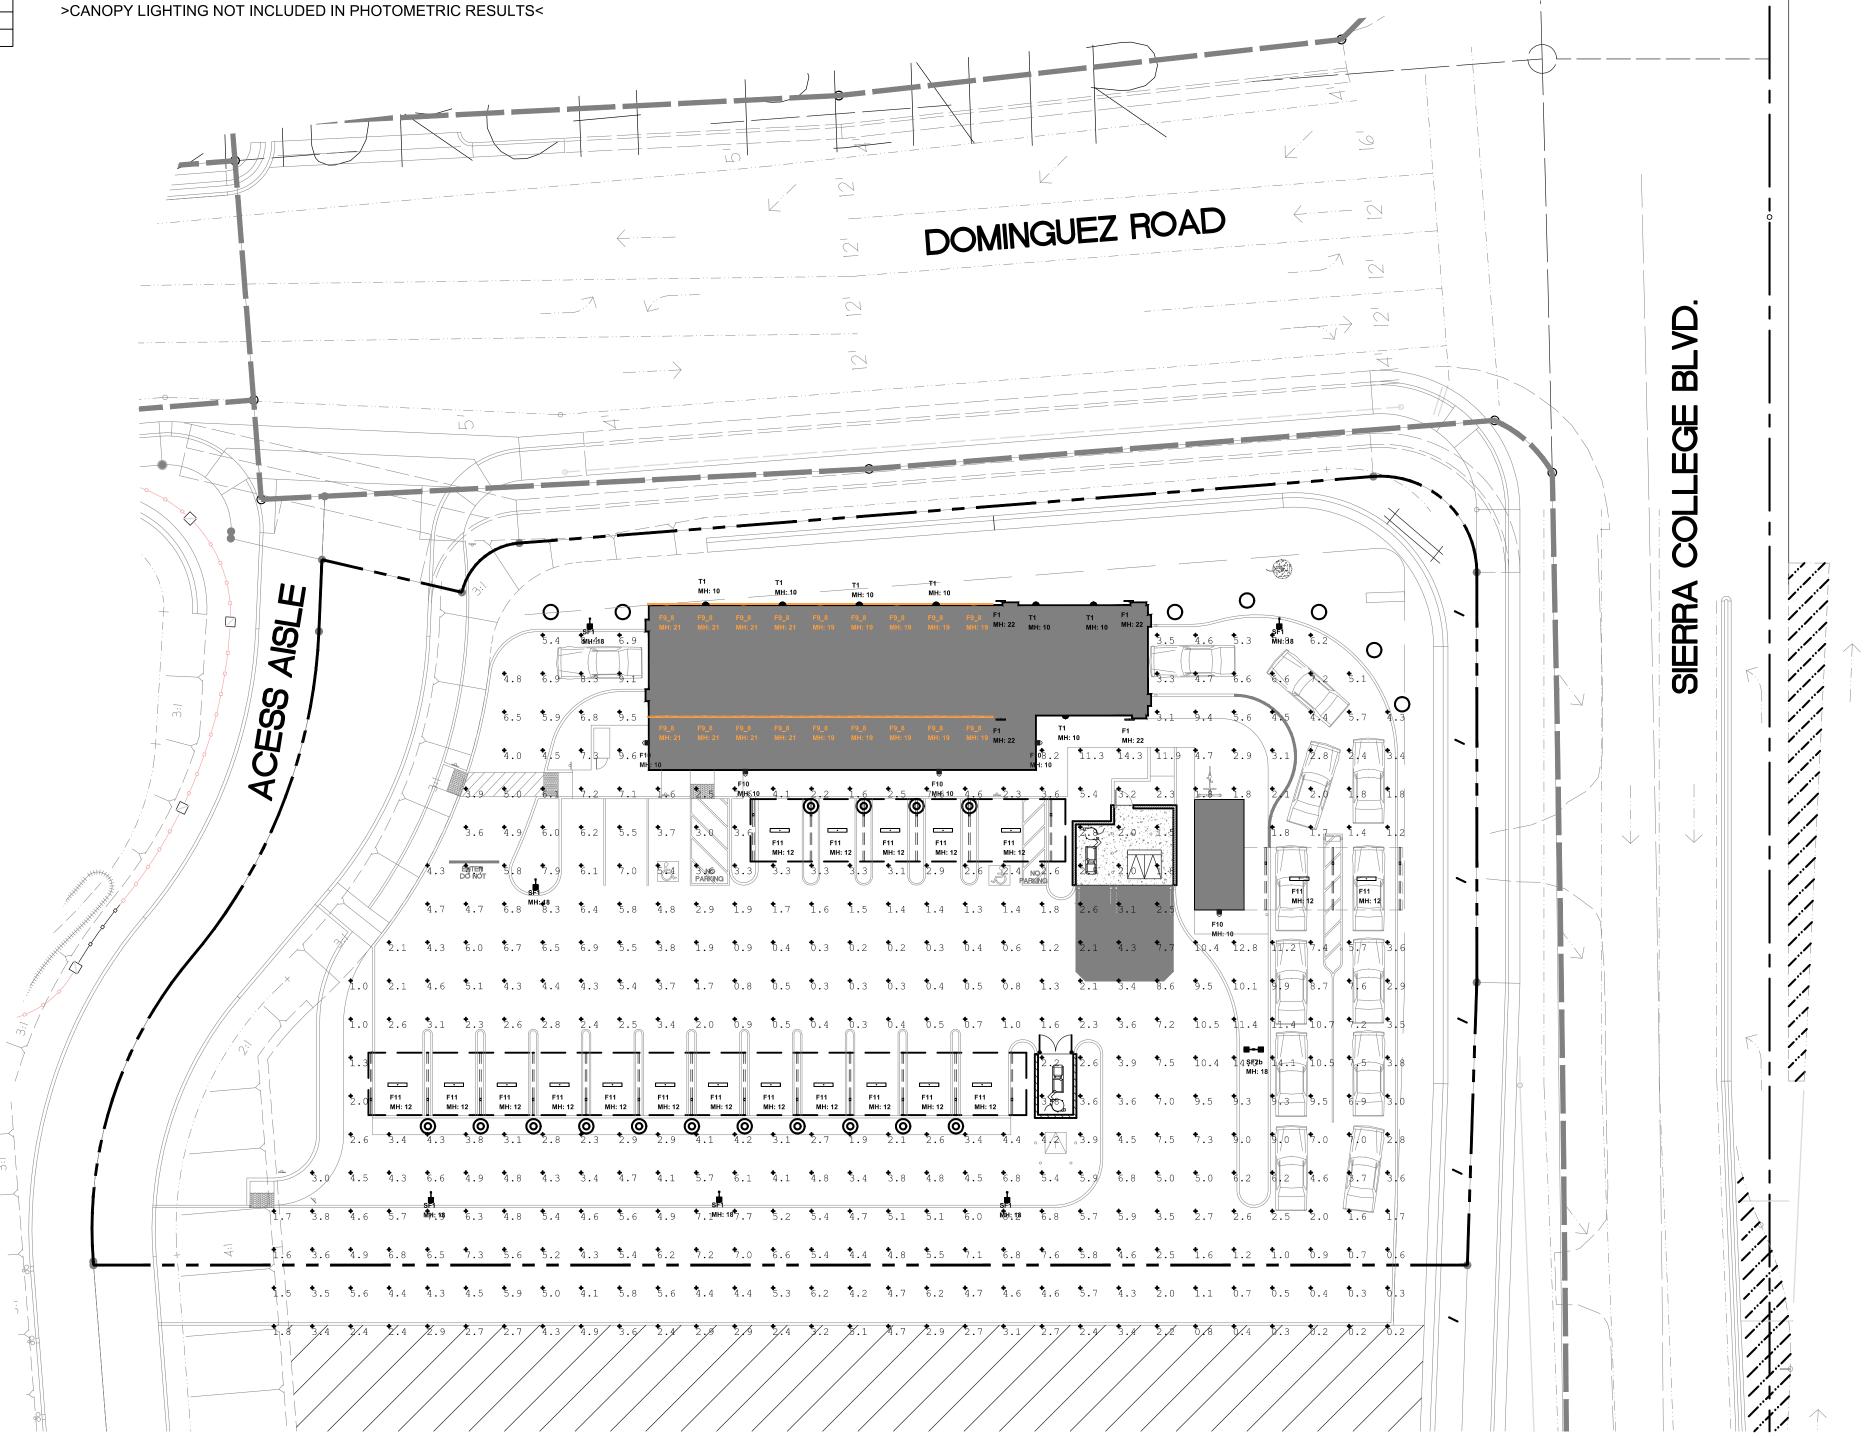



/ Date:12/8/2017

Filename: QQ-171020RKCAJEER2.AGI



1200 92nd Street - Sturtevant, WI 53177

www.cree.com - (800) 236-6800

// SR No. 26717 Scale: 1"=16' Footcandles calculated at grade

Layout by: JACOB EDLER

Illumination results shown on this lighting design are based on project parameters provided to Cree, Inc. used in conjunction with luminaire test procedures conducted under laboratory conditions. Actual project conditions differing from these design parameters may affect field results. The customer is responsible for verifying dimensional accuracy along with compliance with any applicable electrical, lighting, or energy code.



Quick Quack

QUICK QUACK CARWASH 1380 LEAD HILL BLVD #260 ROSEVILLE CA 95661

(916) 846-2100 PROJECT NAME: **QUICK QUACK CARWASH**

SIERRA COLLEGE ROCKLIN, CA. 95677 QQ# 6-021

PHOTOMETRIC SITE PLAN

DRAWING DATE: SEPTEMBER 29, 2017

PLANNING DOCUMENTS

DRAWING TITLE:

DRAWING NUMBER

A2.1



Water Efficient Landscápe Worksheet

HYDROZONE/PLANTING DESCRIPTION	PLANT FACTOR (PF)	IRRIG. METHOD	IRRIG. EFFICIENCY (IE)	ETAF (PF/IE)	LANDSCAPE AREA (Sq. Ft.)	ETAF x AREA	ESTIMATED TOTAL WATER USE (ETWU)
REGULAR LANDSCAPE AREA	•						
LOW WATER USE PLANTS	.3	DRIP	.81	.37	7,664	2,836	111,617 GAL.
MODERATE WATER USE PLANTS	.5	DRIP	.81	.62	1,868	1,158	17,645 GAL.
	•			TOTALS	(A) 9,532	(B) 3,994	

Maximum Applied Water Allowance (MAWA). MAWA= (ETo) (Conversion factor) ((ETAF)(Landscape Area)) + ((1-ETAF) x SLA) + (1-.45) X 0) =138,822 GALLONS (.45 x 9,532)

ETWU Total 129,262 GAL.

= 129,262 GALLONS

Estimated Total Water use (ETWU).


ETWU= (ETO)) (Conversion factor) ((ETAF) (Area)) (52.2) (.62) (3,994)

ETAF Calculations

Regular Landscape Areas


Total ETAF x Area	(B) 3,994
Total Area	(A) 9,532
Average ETAF	(B / A) .42

1. Average ETAF for Regular Landscape Areas must be below .55 for residential areas and .45 for non-residential areas.

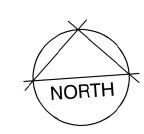

SCALE: 1" = 16'

PLANT SCHEDULE

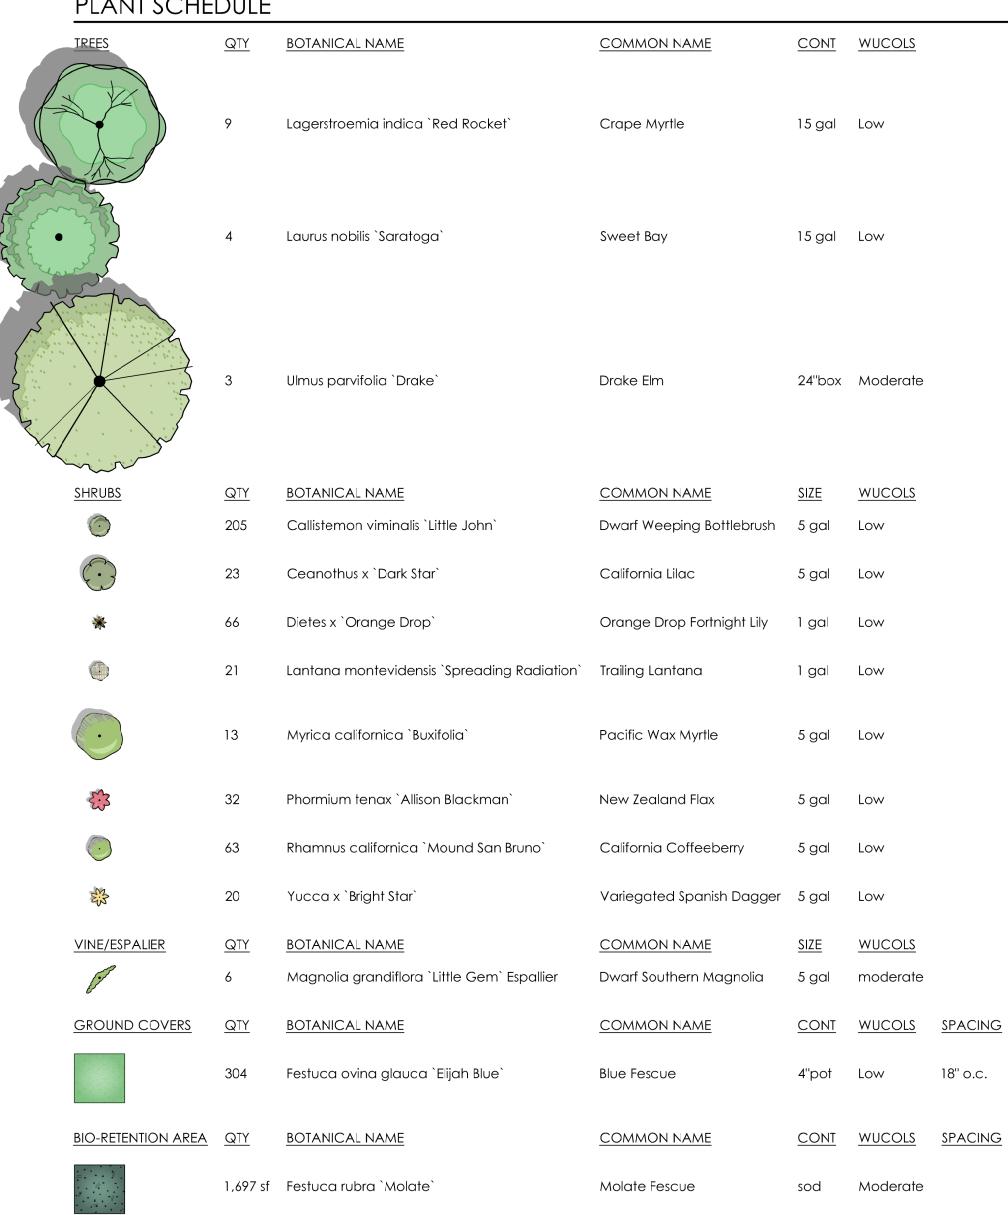

GENERAL NOTES

- 1. A soils fertility analysis report and recommendations by a certified soils analysis laboratory shall be completed prior to construction. Soil samples shall be collected after site rough grading has been completed.
- 2. All landscape planting areas shall receive a minimum 3"-4" layer of organic mulch top dressing.
- 3. All trees, shrubs and groundcover shall be irrigated with a drip system, smart controller, weather sensor, etc.and shall meet City of Rocklin Water Efficient standards/regulations.
- 4. All new trees located within 7' of pavement or permanent structure shall have a root barrier.

ROD SCACCALOSI LANDSCAPE ARCHITECT PO Box 2083 Petaluma CA 94952 707-280-8990 OliveStreetLandscape.com rscac@sbcglobal.net





QUICK QUACK CARWASH 1380 LEAD HILL BLVD #260 ROSEVILLE CA 95661 (916) 846-2100

PROJECT NAME: QUICK QUACK CARWASH SIERRA COLLEGE ROCKLIN, CA. 95677 QQ# 6-021


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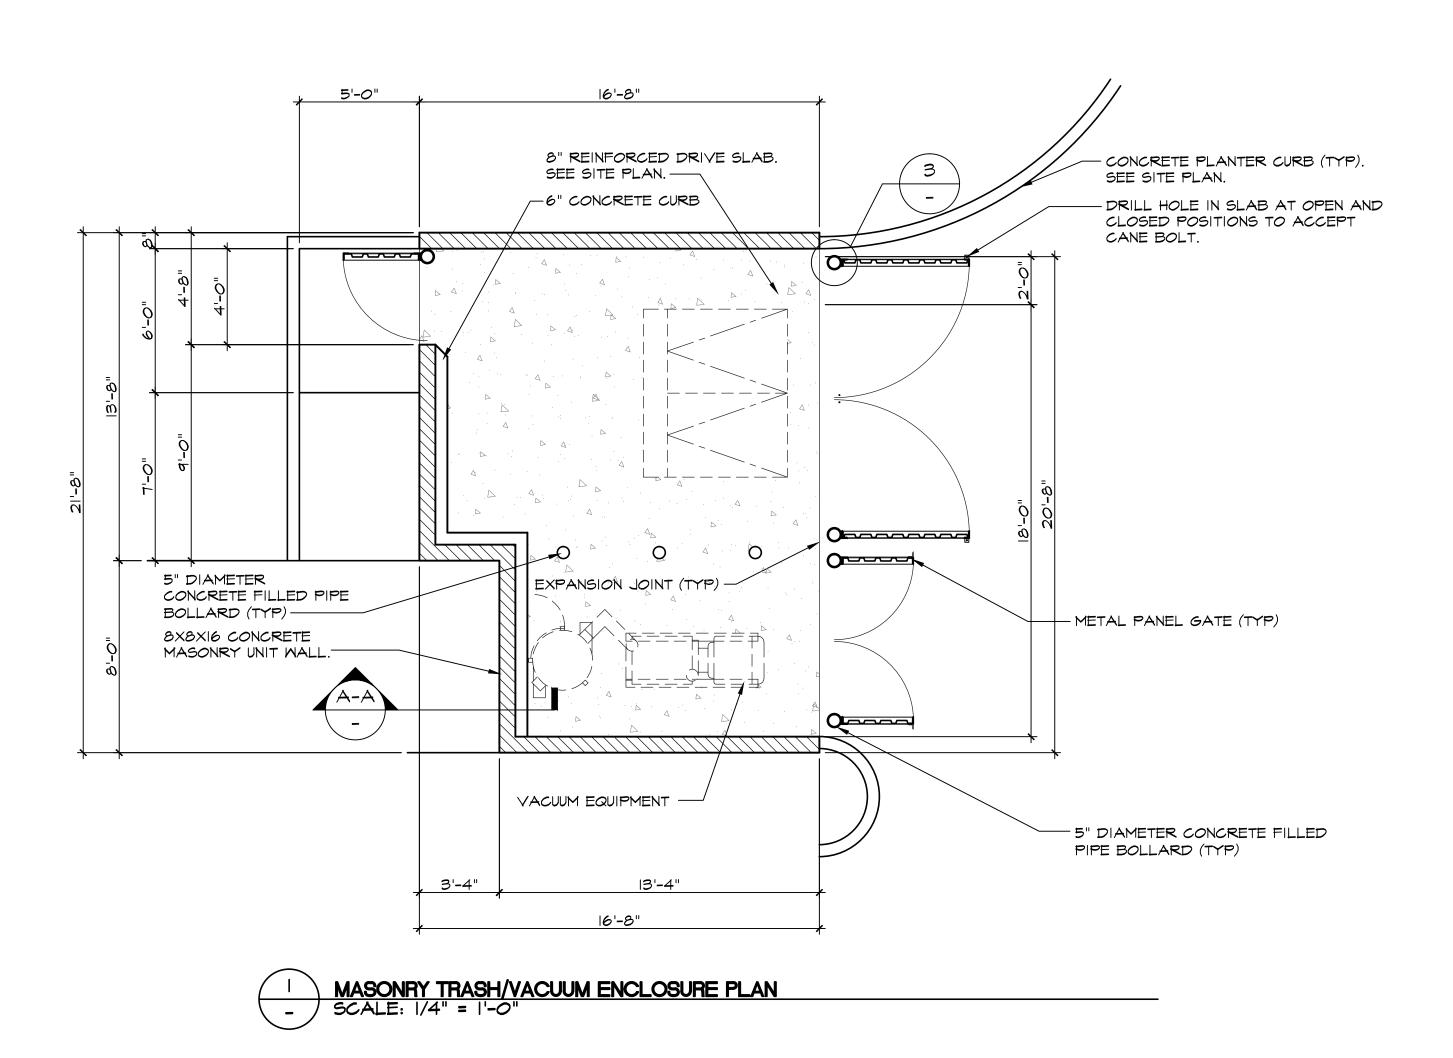
PRELIMINARY LANDSCAPE PLAN


DRAWING DATE: NOVEMBER 4, 2017

PLANNING DOCUMENTS

DRAWING NUMBER



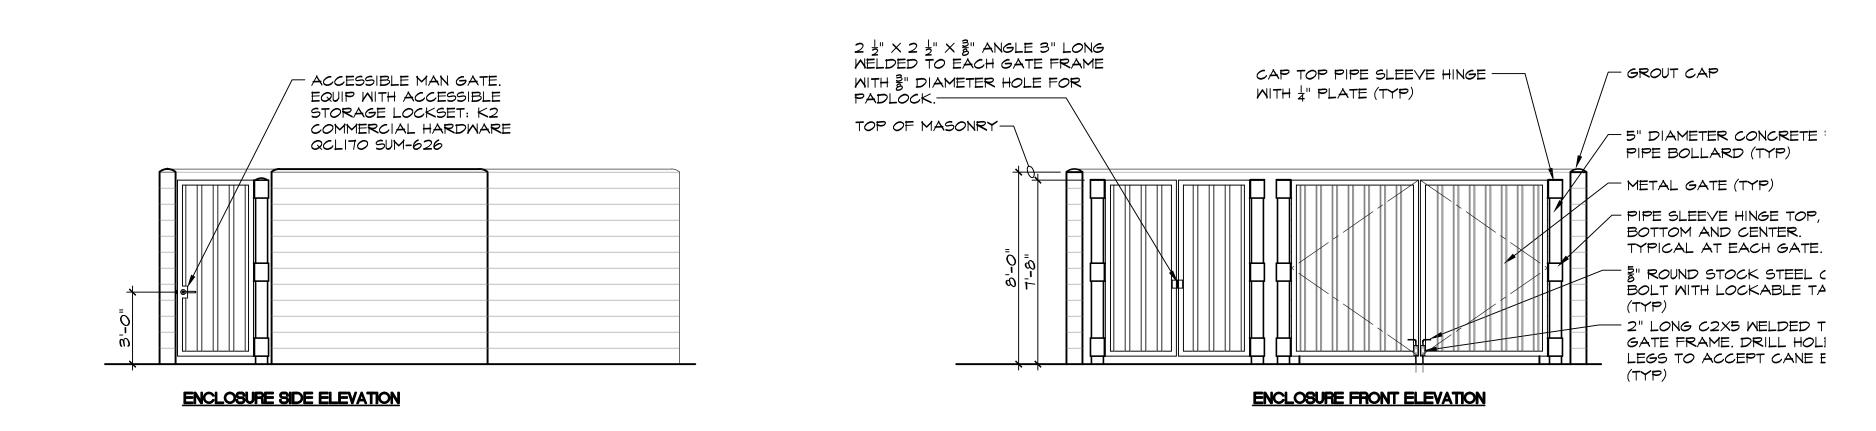

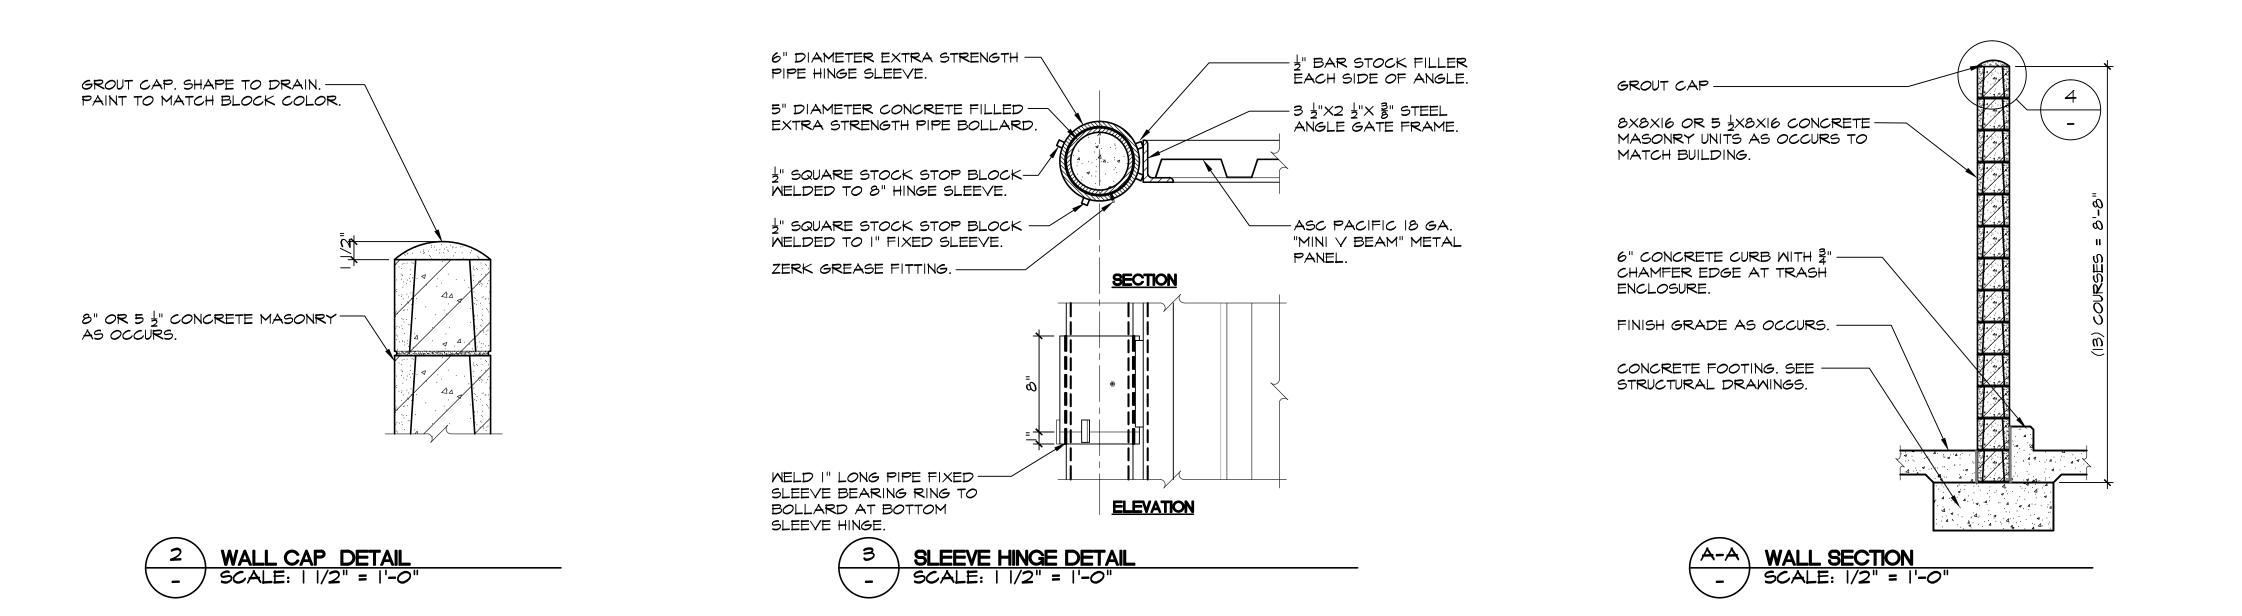







QUICK QUACK CARWASH 1380 LEAD HILL BLVD #260 ROSEVILLE CA 95661 (916) 846-2100

PROJECT NAME:

QUICK QUACK CARWASH
SIERRA COLLEGE
ROCKLIN, CA. 95677
QQ# 6-021

DRAWING TITLE:


SITE ELEMENTS

DRAWING DATE: SEPTEMBER 29, 2017

PLANNING DOCUMENTS

DRAWING NUMBER

A2.3

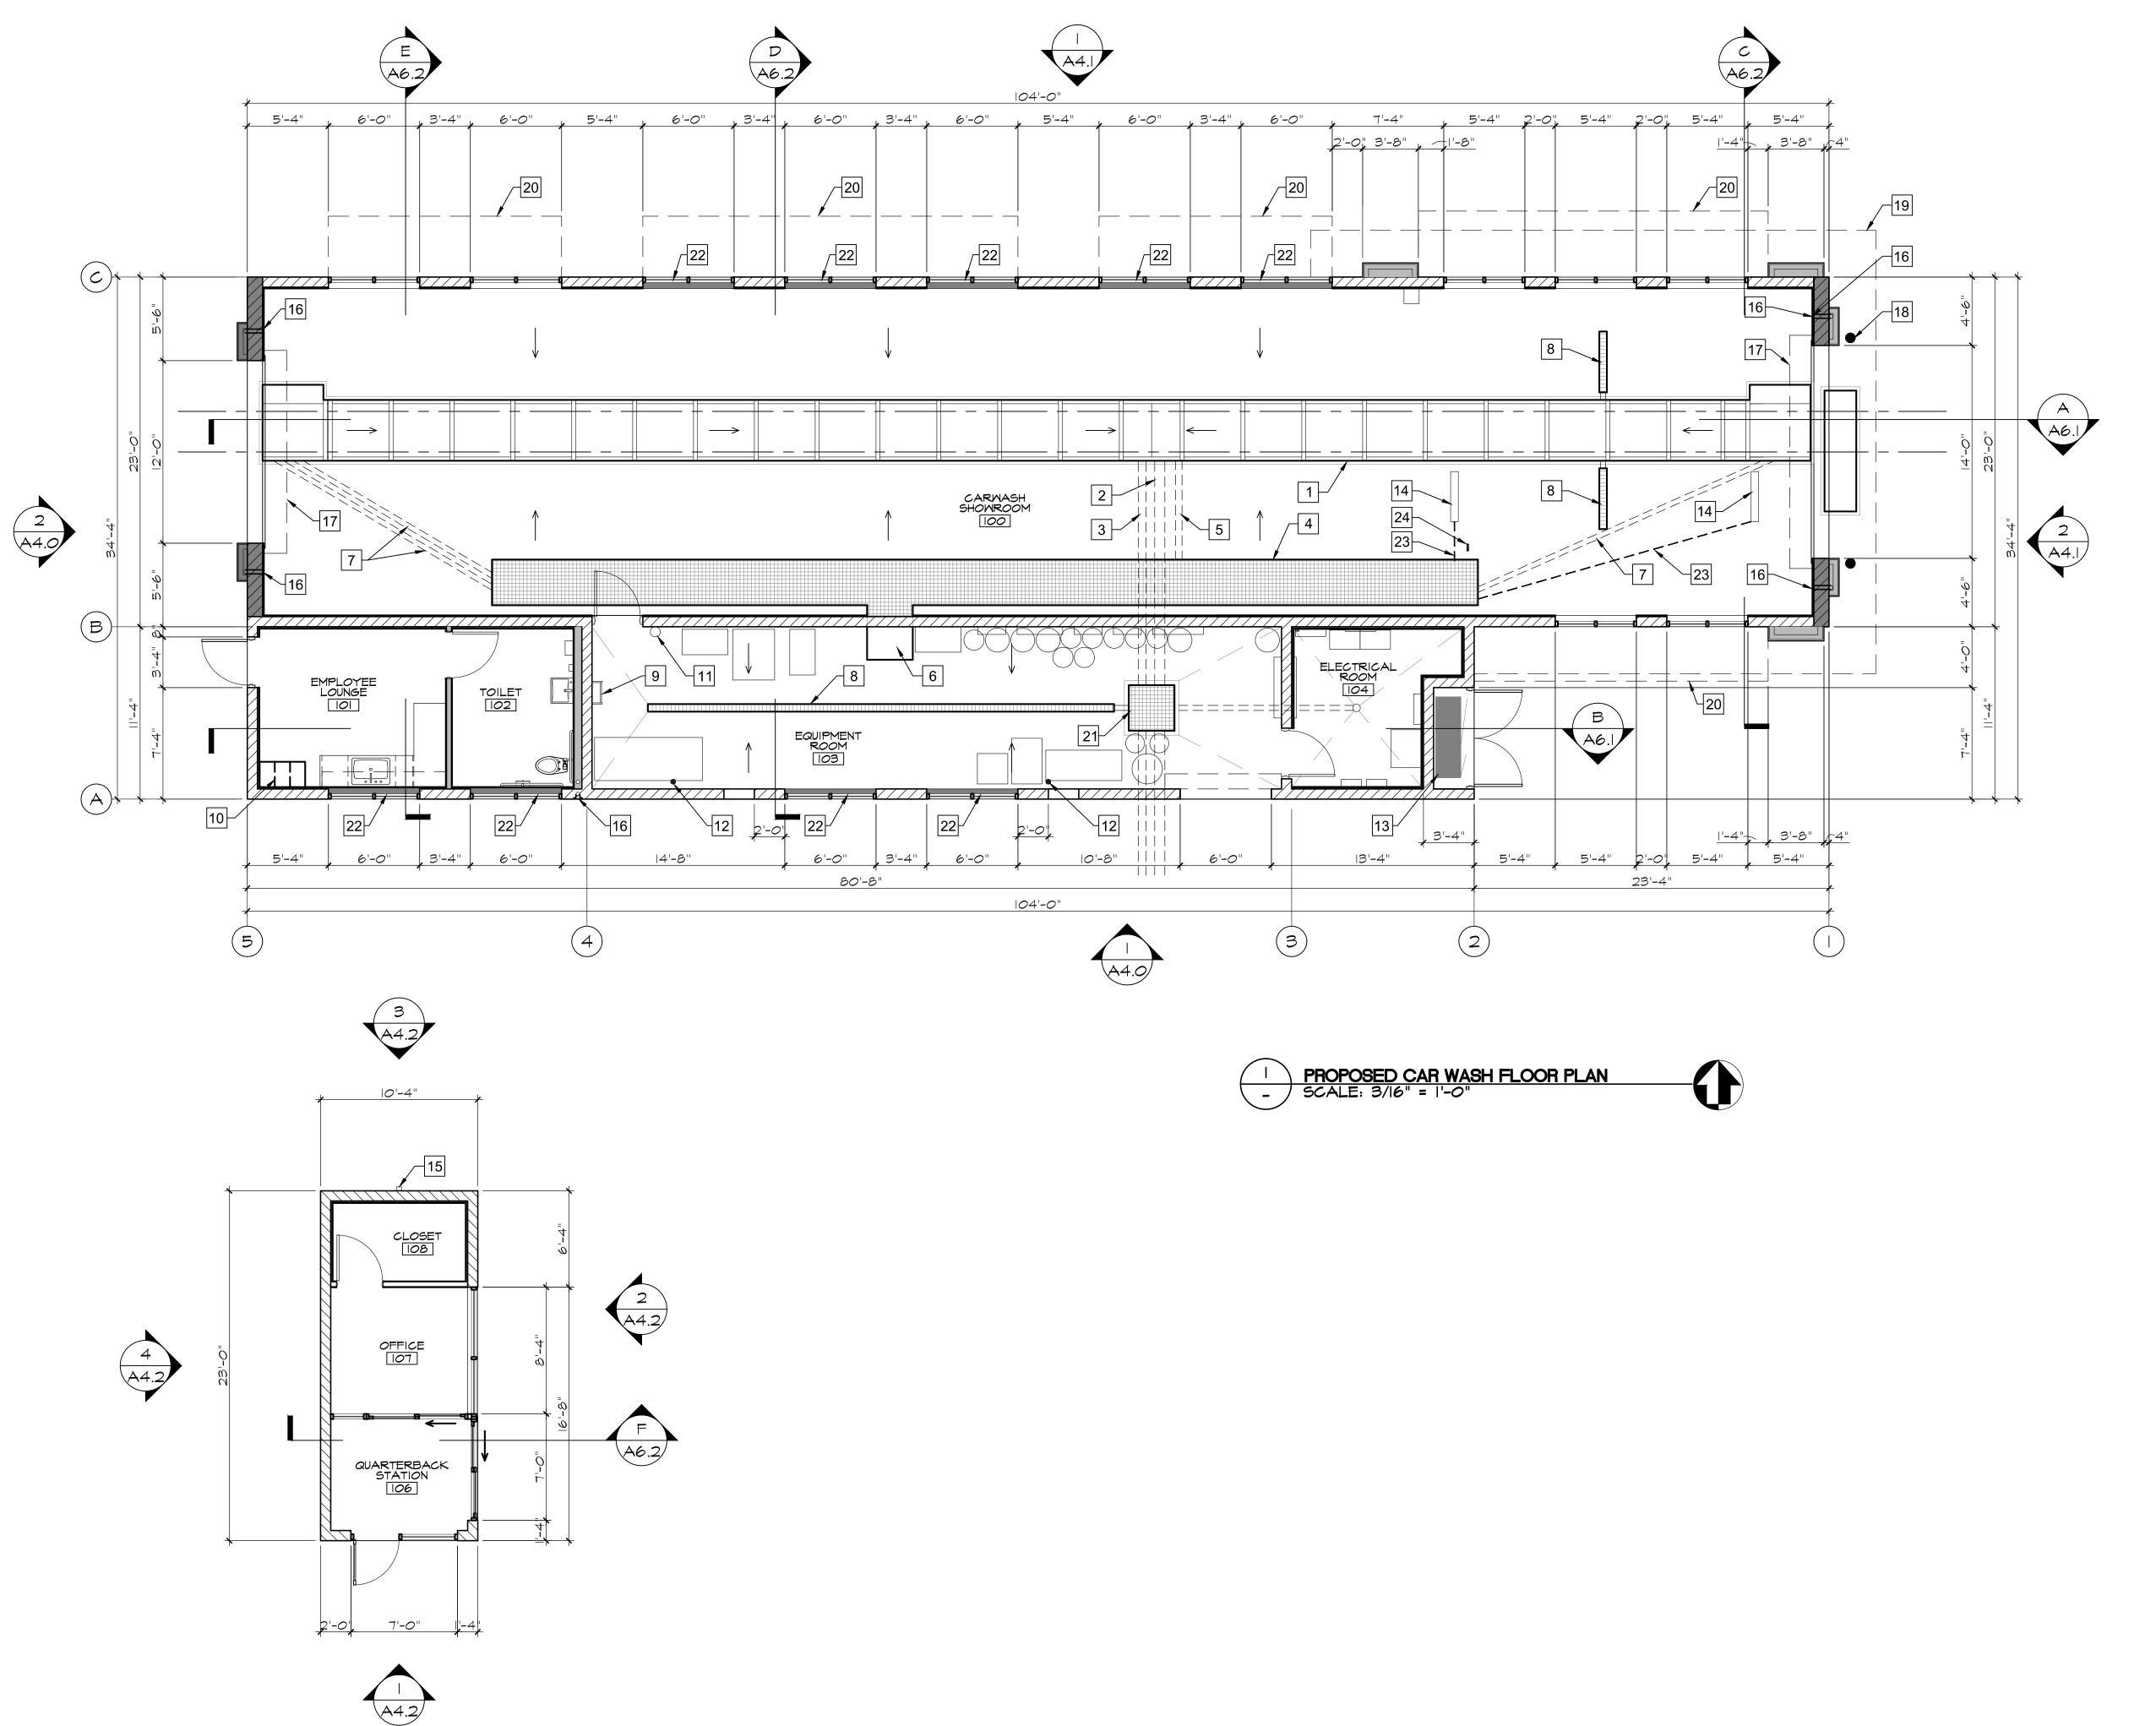

PROPOSED QUARTERBACK STATION FLOOR PLAN

SCALE: 3/16" = 1'-0"

KEYNOTES

1 CONVEYOR TRENCH. SLOPE AT $\frac{1}{4}$ " PER FOOT TO DRAIN.

2 8" CONVEYOR TRENCH DRAIN PIPE.

3 6" CONVEYOR TRENCH OVERFLOW.

4 UTILITY TRENCH. SLOPE BOTTOM TO DRAIN.

5 5" UTILITY TRENCH DRAIN PIPE. SLOPE TO CONVEYOR TRENCH.

6 OPEN FOR ACCESS TO UTILITY TRENCH.

7 4" PIPE CHASE FROM UTILITY TRENCH TO CONVEYOR TRENCH.

8 TRENCH DRAIN.

9 ROOF ACCESS LADDER.

10 EMPLOYEE LOCKERS.

11 WALL MOUNTED FIRE EXTINGUISHER.

12 ROOF DRAIN LEADER.

13 ELECTRICAL SERVICE SMITCHGEAR.

14 3/4" RECESS IN SLAB FOR TIRE SENSOR SWITCH.

15 DOWNSPOUT - SEE EXTERIOR ELEVATIONS

HOSE BIB IN RECESS BOX. PROVIDE WITH LOCKABLE DOOR AT EXTERIOR LOCATIONS.

17 COILING ROLL-UP DOOR.

18 CONCRETE FILLED PIPE BOLLARD AT ENTRANCE.

19 LINE OF ROOF ABOVE.

20 WALL MOUNTED CANOPY ABOVE.

21 3'-0" X 3'-0" RECLAIM CLEAN-OUT.

22 FAUX WINDOW - SEE EXTERIOR ELEVATIONS

23 1/2" CONDUIT TO TIRE SWITCH

24 3 - I" CONDUIT FROM CONTROLLER



OWNER -



QUICK QUACK CARWASH 1380 LEAD HILL BLVD #260 ROSEVILLE CA 95661 (916) 846-2100

PROJECT NAME:

QUICK QUACK CARWASH
SIERRA COLLEGE
ROCKLIN, CA. 95677
QQ# 6-021

DRAWING TITLE:


PROPOSED FLOOR PLAN


DRAWING DATE: SEPTEMBER 29, 2017

PLANNING DOCUMENTS


DRAWING NUMBER

A3.0

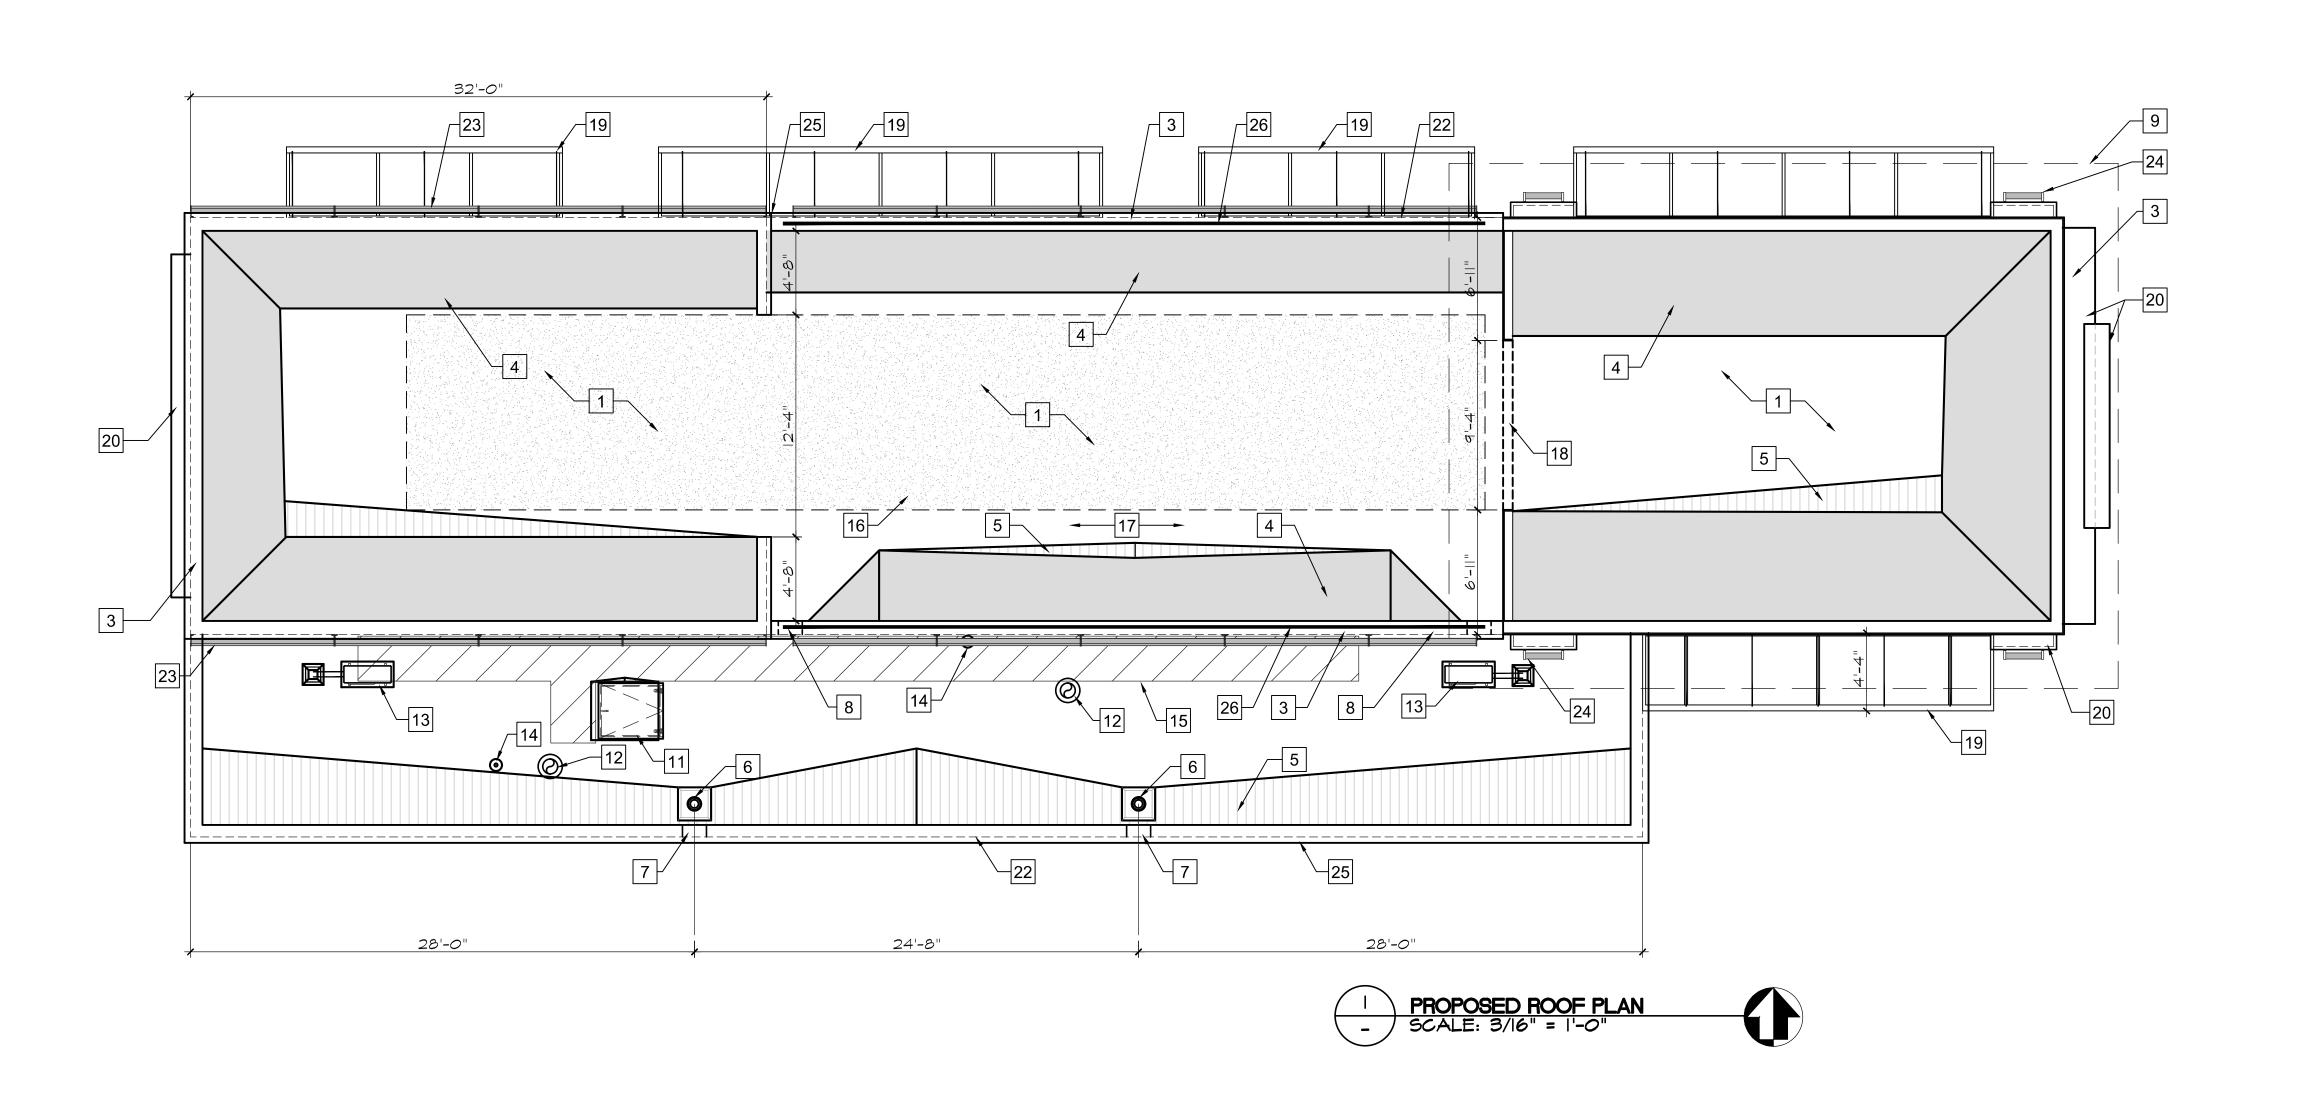

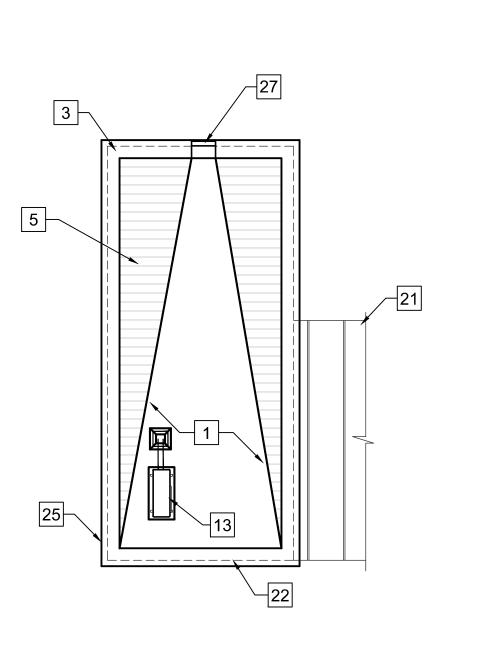



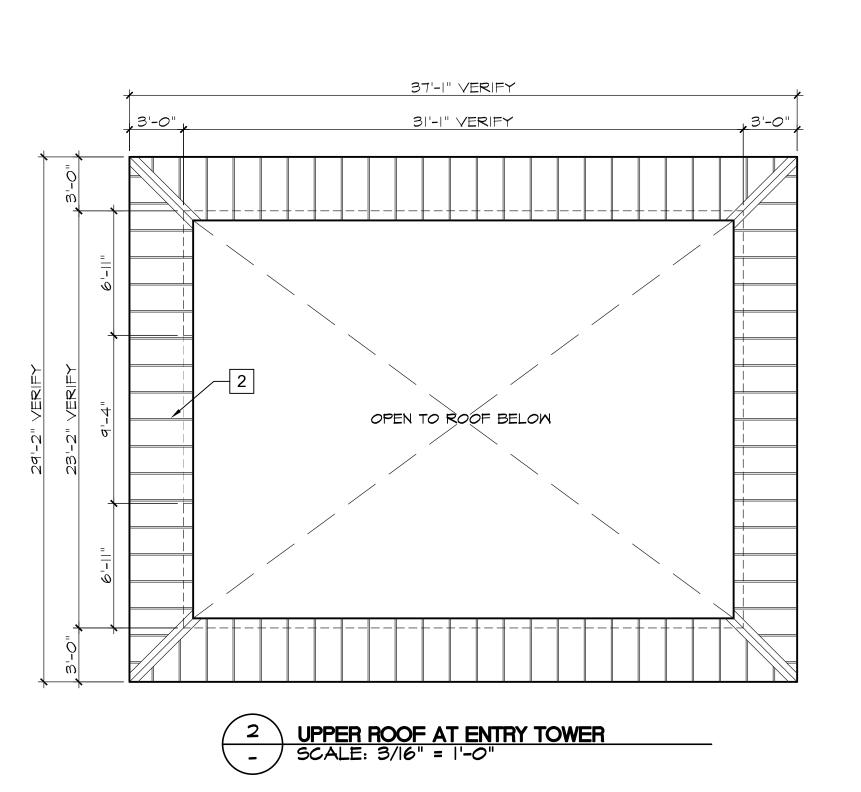

KEYNOTES

- 1 TPO MEMBRANE ROOFING.
- 2 STANDING SEAM METAL ROOFING.
- 3 PRE-FINISHED METAL COPING AT TOP OF PARAPET WALL.
- ROOF CRICKET. $\frac{1}{2}$ " ROOF SHEATHING OVER METAL STUD DIAGONAL BRACING SLOPE AT ONE TO ONE.
- 5 TAPERED RIGID INSULATION CRICKET WITH $\frac{1}{4}$ " ISOLATION BOARD (TYP).
- 6 ROOF DRAIN IN RECESS.
- 7 THROUGH WALL OVERFLOW SCUPPER.
- 8 THROUGH WALL SCUPPER. SPILL TO ROOF BELOW.
- 9 OUTLINE OF UPPER ROOF AT ENTRY TOWER. SEE ABOVE.
- 10 NOT USED
- 11 ROOF ACCESS LADDER HATCH.
- 12 EXHAUST FAN UNIT. SEE MECHANICAL DRAWINGS.
- 13 MECHANICAL UNIT TO BE CONCEALED FROM VIEW BY PARAPET.
- 14 PLUMBING VENT.
- 15 ROOF WALK PATH OVERLAY.
- 16 ROOF AREA DEDICATED TO POSSIBLE FUTURE SOLAR PANEL INSTALLATION.
- 17 ROOF AREA DEDICATED TO MAINTENANCE ACCESS TO POSSIBLE FUTURE SOLAR INSTALLATION.
- 18 OPENING IN WALL BETWEEN CRICKETS.
- 19 WALL MOUNTED METAL CANOPY BELOW (TYP).
- 20 CEMENT PLASTER FINISH AT TOP OF FURRED WALL FEATURE (TYP).
- 21 METAL PAY STATION CANOPY (SEE PAY CANOPY ELEVATIONS)
- 22 WALL BELOW SHOWN DASHED.
- 23 LINEAR DOWN LIGHTING
- 24 2 FOOT PILASTER LIGHTS
- 25 FOAM TRIM WITH PLASTER FINISH COAT SEE EXTERIOR ELEVATIONS
- 26 DECORATIVE IRON WORK RAILING SEE EXTERIOR ELEVATIONS
- 27 COLLECTOR AND DOWNSPOUT SEE EXTERIOR ELEVATIONS





QUICK QUACK CARWASH 1380 LEAD HILL BLVD #260 ROSEVILLE CA 95661 (916) 846-2100

PROJECT NAME: QUICK QUACK CARWASH SIERRA COLLEGE ROCKLIN, CA. 95677 QQ# 6-021


DRAWING TITLE: PROPOSED ROOF PLAN


DRAWING DATE: SEPTEMBER 29, 2017

PLANNING DOCUMENTS

DRAWING NUMBER

A3.1

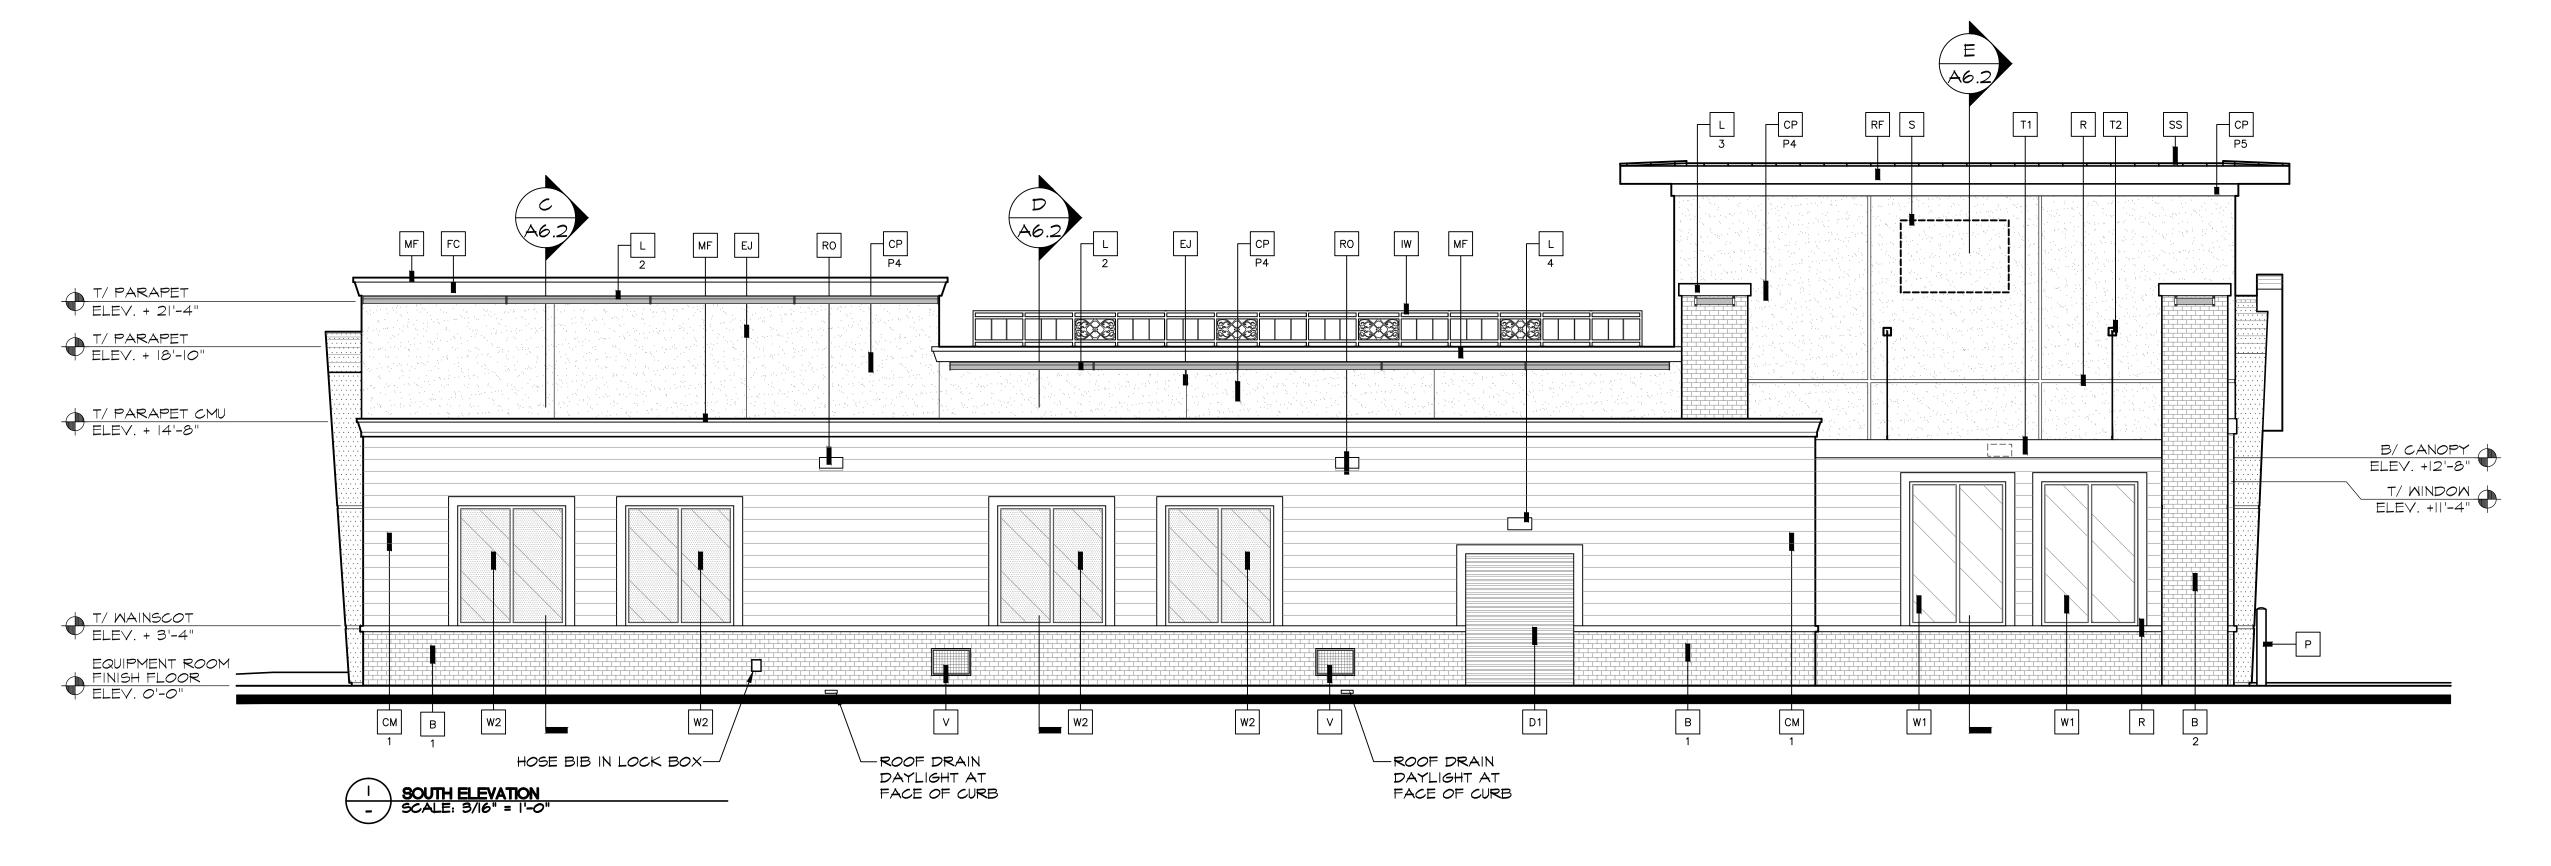

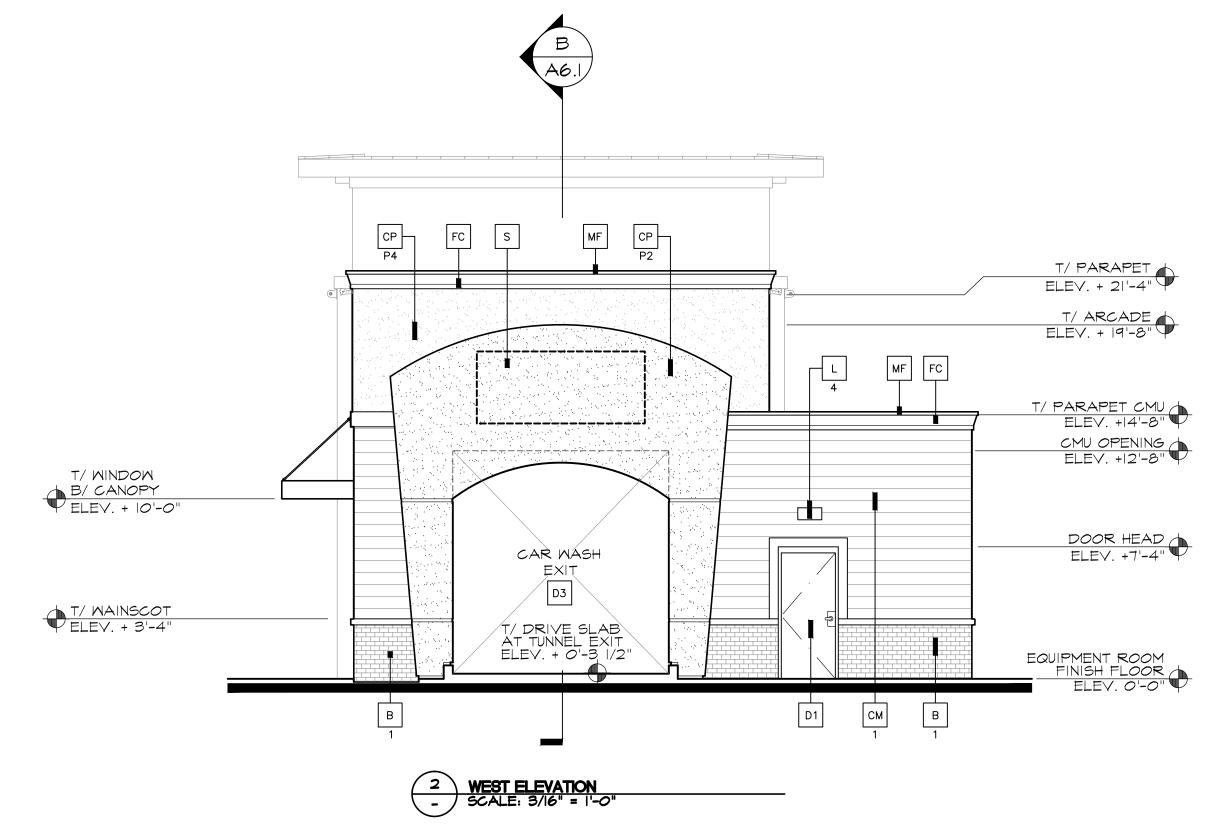

KEY NOTES:

- THIN BRICK WAINSCOT. H. C. MUDDOX 1717 "SIERRA SLATE". THIN SET OVER CONCRETE MASONRY UNIT CONSTRUCTION. MORTAR COLOR MAPEI 39 "IVORY".
- BRICK VENEER SILL SHAPE. H.C. MUDDOX "SIERRA SLATE". MORTAR COLOR TO MATCH BRICK.
- ANGELUS BLOCK "PLACER CREEK BURNISHED" MEDIUM WEIGHT WITH INTEGRAL FACTORY "RAINBLOC" WATER REPELLENT ADMIXTURE. MORTAR TO HAVE "RAINBLOC" FOR MORTAR ADMIXTURE. GROUT BY SPEC MIX MORTOR #249.
- CP ACRYLIC PLASTER COLOR COAT
- P-COLOR DESIGNATION:
- PI = MATCH SHERWIN WILLIAMS #6123 "BAGUETTE" P2 = MATCH SHERWIN WILLIAMS #6374 "TORCHLIGHT"
- P3 = MATCH SHERWIN WILLIAMS #7004 "SNOWBOUND" P4 = MATCH SHERWIN WILLIAMS #6120 "BELIEVABLE BUFF" P5 = MATCH SHERWIN WILLIAMS #6034 "ARRESTING AUBURN"
- PLASTER COLOR COAT TO BE SAND FINISH
- CT 3" X 9 4" CEMENTITIOUS TRIM WITH RUSTIC FINISH. "HARDIE BOARD" OR EQUAL. PAINT SHERWIN WILLIAMS #6034 "ARRESTING AUBURN".
- HOLLOW METAL DOOR PAINT TO TO MATCH SHERWIN WILLIAMS #6123 "BAGUETTE"
- D2 CLEAR ANODIZED ALUMINUM COMMERCIAL SLIDING GLASS DOOR

- OVERHEAD METAL DOOR PAINT TO TO MATCH SHERWIN WILLIAMS #7025 "BACKDROP"
- EJ 4" DEEP REVEAL EXPANSION JOINT

L4 = WALL PACK (DOWN ONLY)

- FO FOAM CORNICE WITH PLASTER FINISH COAT 10 P SHERWIN WILLIAMS #6034 "ARRESTING AUBURN" FOAM CORNICE WITH PLASTER FINISH COAT TO MATCH
- DECORATIVE IRON WO #3135P "NEW EBONY" DECORATIVE IRON WORK RAILING - SHERWIN WILLIAMS
- LIGHT FIXTURE
- ¹_TYPE:
 - LI = LED RADIAL WALL SCONCE (DOWN ONLY) L2 = LINEAR FACADE WALL LIGHT (DOWN ONLY) L3 = 2 FOOT LED PILASTER LIGHT (DOWN ONLY)
 - CONTACT STEVE FRIEDMAN 1.262.504.5479 WITH CREE LIGHTING FOR ORDERING LIGHTING. (NO EXCEPTIONS)

- METAL FASCIA PAINT SHERWIN WILLIAMS #6034 "ARRESTING AUBURN"
- P 6" PIPE BOLLARD FILLED WITH CONCRETE MATCH SHERWIN WILLIAMS #6374 "TORCHLIGHT".
- R 2" WIDE X 1/4" DEEP ALUMINUM PLASTER REVEAL PAINT TO MATCH "6034 ARRESTING AUBURN"
- RF METAL ROOF FASCIA MATC #6034 "ARRESTING AUBURN" METAL ROOF FASCIA - MATCH SHERMAN WILLIAMS
- ROOF OVERFLOW SCUPPER PAINT TO MATCH ADJACENT FINISH
- S SIGNAGE BY OTHERS SHOWN DASHED- FOR REFERENCE ONLY UNDER SEPARATE PERMIT. GENERAL CONTRACTOR TO COORDINATE WITH SIGN COMPANY.

SS STANDING SEAM METAL ROOF - FIRESTONE - UC3

BRANDY WINE".

- METAL WALL CANOMI SISILIN SHERWIN WILLIAMS #6055 "FIERY BROWN"
- MALL CANOPY TIE-BACK SYSTEM COLOR SHERWIN WILLIAMS #3135P "NEW EBONY"

METAL WALL CANOPY SYSTEM - COLOR TO MATCH

- V 24" MIDE X 16" HIGH VENT PAINT TO MATCH ADJACENT FINISH
- WI EXTERIOR WINDOW ASSEMBLY TEMPERED GLASS DARK BRONZE ANODIZED ALUMINUM STOREFRONT
- W2 FAUX WINDOW ASSEMBLY TEMPERED SPANDREL GLASS DARK BRONZE ANODIZED ALUMINUM STOREFRONT



OWNER -



QUICK QUACK CARWASH 1380 LEAD HILL BLVD #260 ROSEVILLE CA 95661 (916) 846-2100

PROJECT NAME: **QUICK QUACK CARWASH** SIERRA COLLEGE ROCKLIN, CA. 95677


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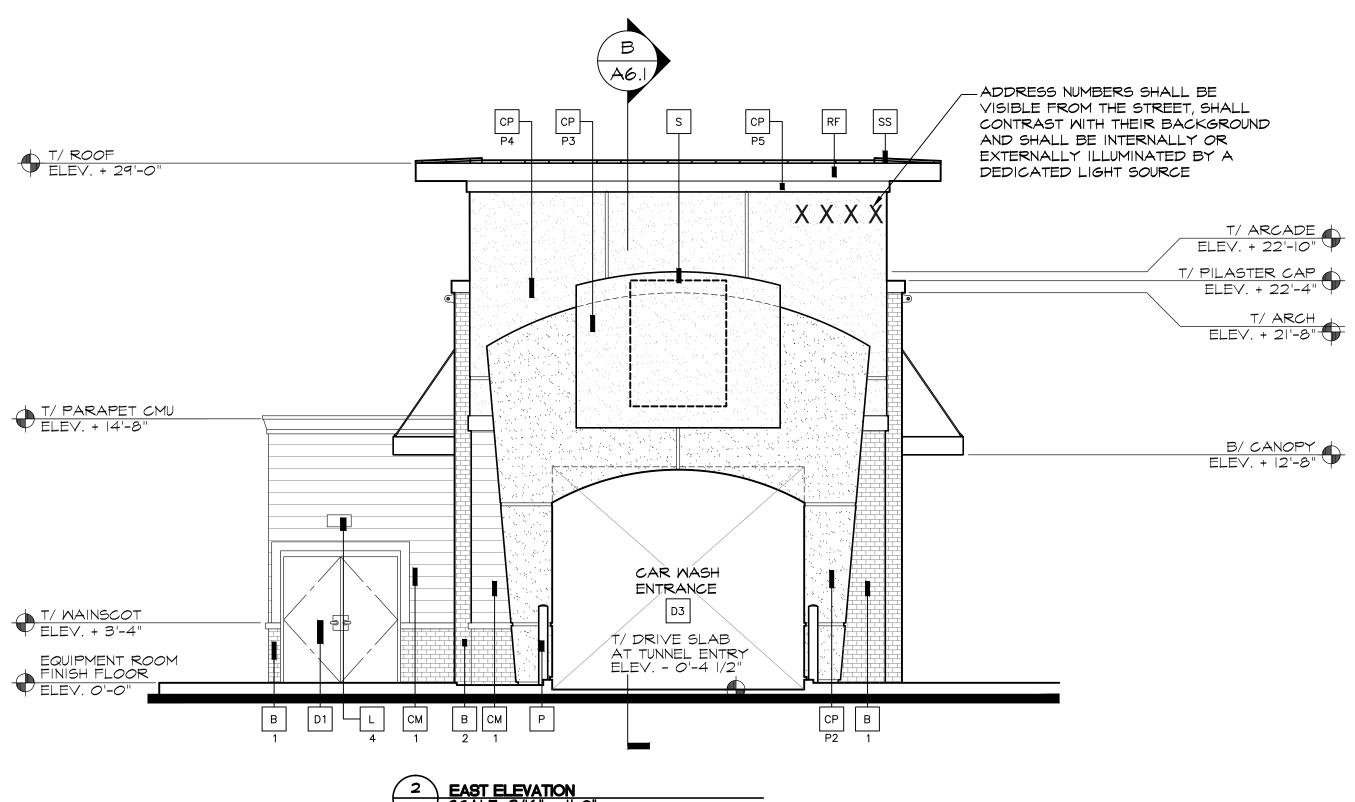
> **EXTERIOR ELEVATIONS**

DRAWING DATE: SEPTEMBER 29, 2017

PLANNING DOCUMENTS

DRAWING NUMBER



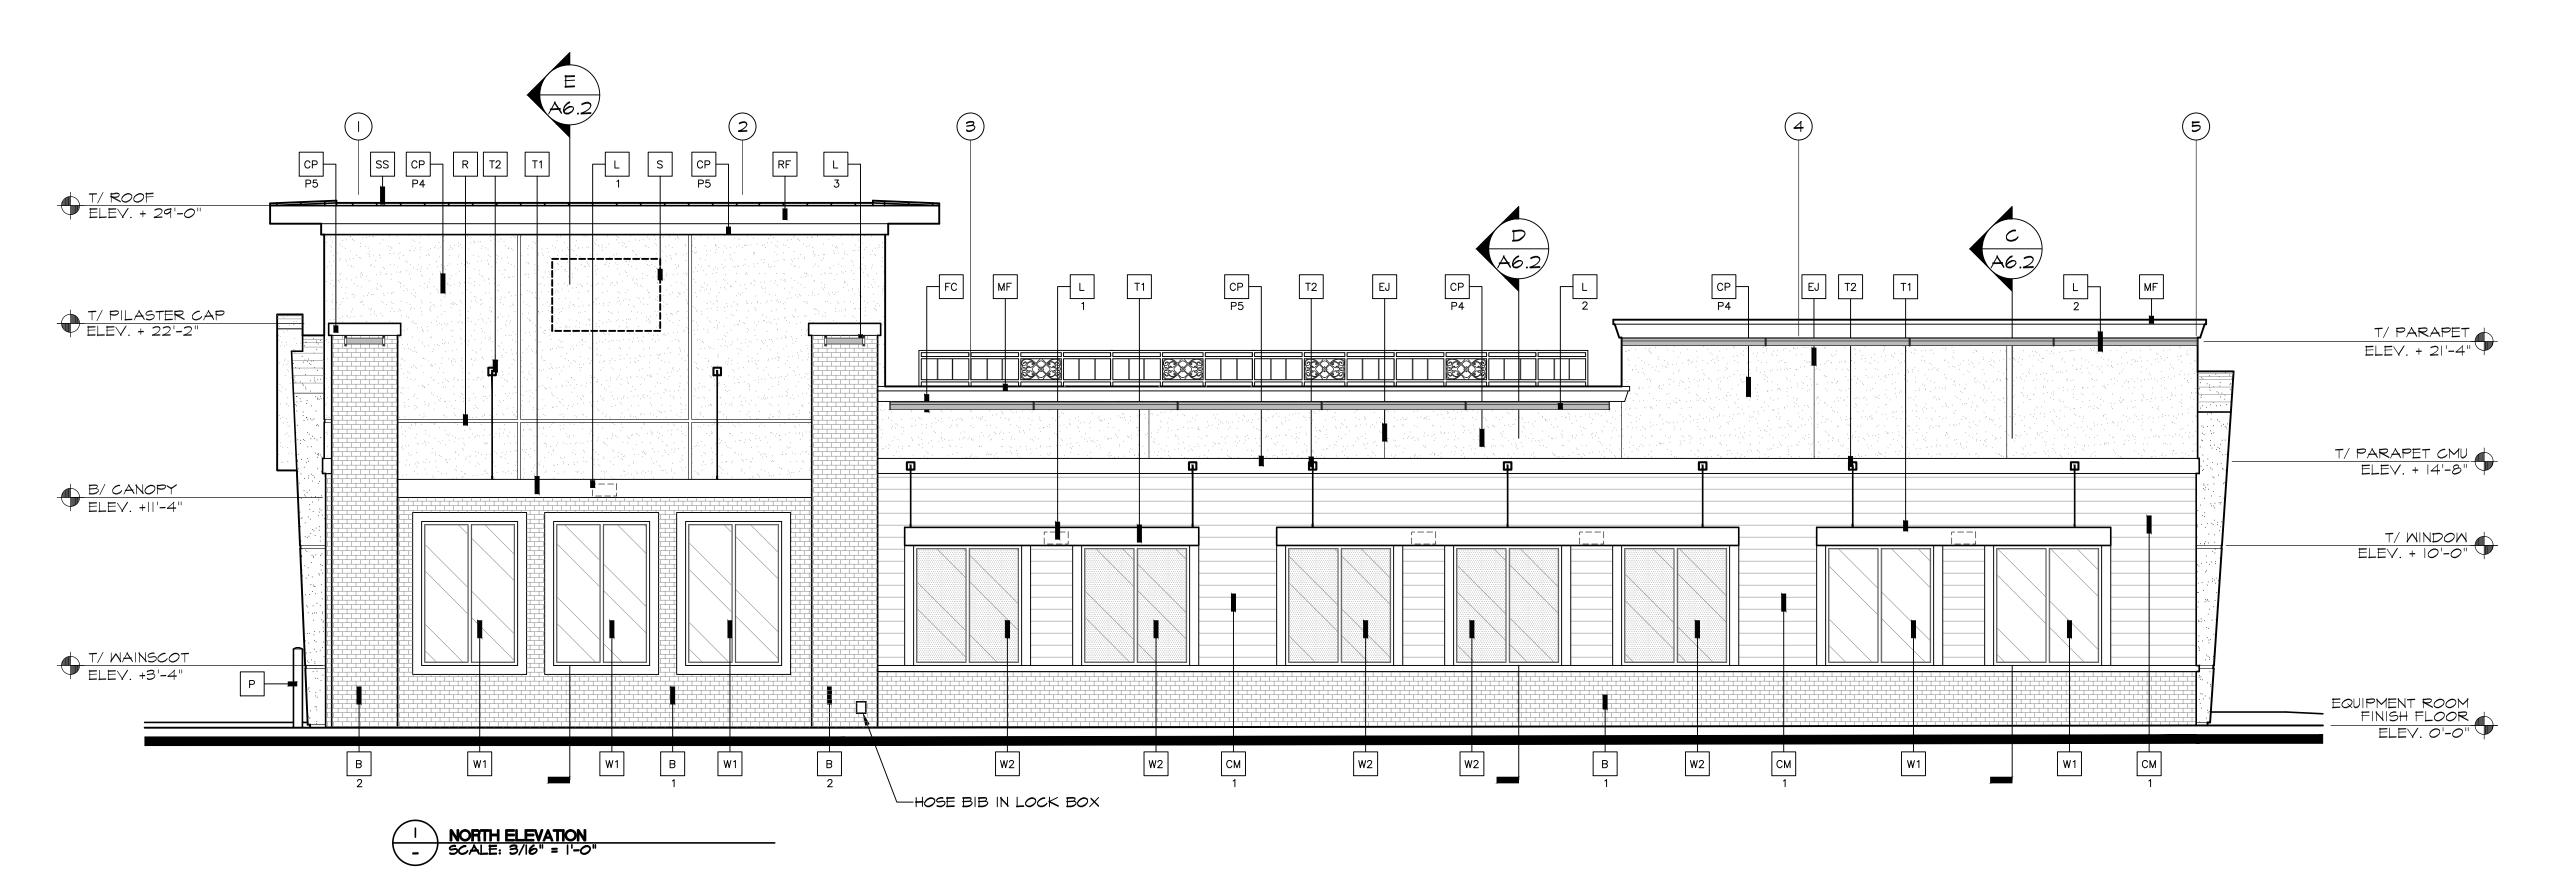

KEY NOTES:

- THIN BRICK WAINSCOT. H. C. MUDDOX 1717 "SIERRA SLATE". THIN SET OVER CONCRETE MASONRY UNIT CONSTRUCTION. MORTAR COLOR MAPEI 39 "IVORY".
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- CLEAR ANODIZED ALUMINUM COMMERCIAL SLIDING GLASS DOOR

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- EJ 4" DEEP REVEAL EXPANSION JOINT
- FOAM CORNICE WITH PLASTER FINISH COAT TO MATCH SHERWIN WILLIAMS #6034 "ARRESTING AUBURN"
- DECORATIVE IRON WORK RAILING SHERWIN WILLIAMS #3135P "NEW EBONY"
- LIGHT FIXTURE
 - LI = LED RADIAL WALL SCONCE (DOWN ONLY) L2 = LINEAR FACADE WALL LIGHT (DOWN ONLY)

L4 = WALL PACK (DOWN ONLY)

CONTACT STEVE FRIEDMAN 1.262.504.5479 WITH CREE LIGHTING FOR ORDERING LIGHTING. (NO EXCEPTIONS)

L3 = 2 FOOT LED PILASTER LIGHT (DOWN ONLY)

- METAL FASCIA PAINT SHERMIN WILLIAMS #6034
 "ARRESTING AUBURN" "ARRESTING AUBURN"
- 6" PIPE BOLLARD FILLED WITH CONCRETE MATCH SHERWIN WILLIAMS #6374 "TORCHLIGHT".
- 2" WIDE X 1/4" DEEP ALUMINUM PLASTER REVE PAINT TO MATCH "6034 ARRESTING AUBURN" 2" WIDE X 1/4" DEEP ALUMINUM PLASTER REVEAL
- METAL ROOF FASCIA MATCH SHERMAN WILLIAMS #6034 "ARRESTING AUBURN"
- ROOF OVERFLOW SCUPPER PAINT TO MATCH ADJACENT FINISH
- SIGNAGE BY OTHERS SHOWN DASHED- FOR REFERENCE ONLY UNDER SEPARATE PERMIT. GENERAL CONTRACTOR TO COORDINATE WITH SIGN COMPANY.
- SS STANDING SEAM METAL ROOF FIRESTONE UC3 "BRANDY WINE".

- METAL WALL CANOMY STRIET COLO. . . . SHERWIN WILLIAMS #6055 "FIERY BROWN" METAL WALL CANOPY SYSTEM - COLOR TO MATCH
- MALL CANOPY TIE-BACK STOLE WILLIAMS #3135P "NEW EBONY" WALL CANOPY TIE-BACK SYSTEM - COLOR SHERWIN
- 24" WIDE X 16" HIGH VENT PAINT TO MATCH
- V 24" WIDE X 16" HIGH ADJACENT FINISH
- WI EXTERIOR WINDOW ASSEMBLY TEMPERED GLASS DARK BRONZE ANODIZED ALUMINUM STOREFRONT
- FAUX WINDOW ASSEMBLY TEMPERED SPANDREL GLASS DARK BRONZE ANODIZED ALUMINUM STOREFRONT





QUICK QUACK CARWASH 1380 LEAD HILL BLVD #260 ROSEVILLE CA 95661 (916) 846-2100

PROJECT NAME: **QUICK QUACK CARWASH** SIERRA COLLEGE ROCKLIN, CA. 95677


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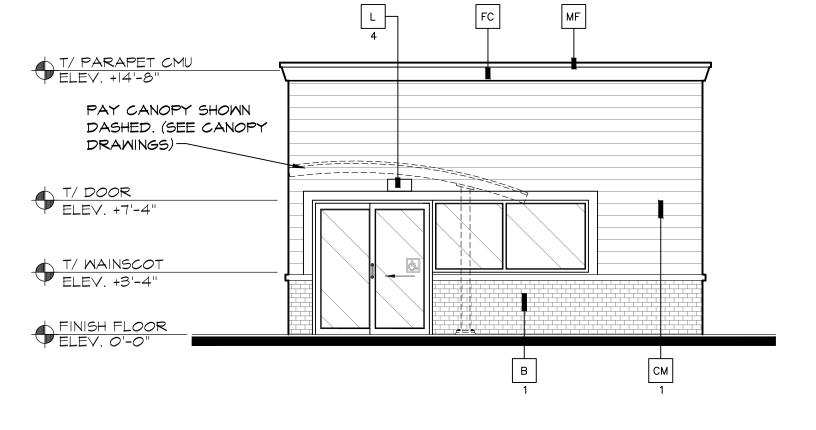
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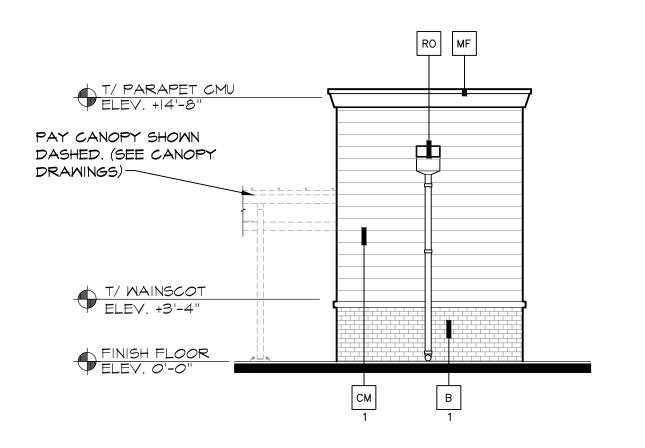
DRAWING DATE: SEPTEMBER 29, 2017


PLANNING DOCUMENTS

DRAWING NUMBER





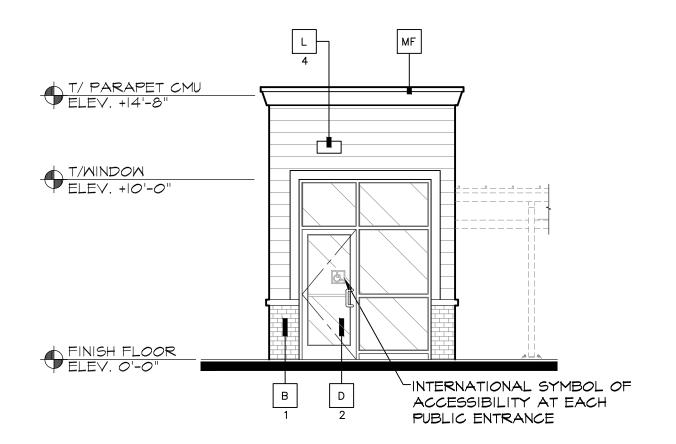

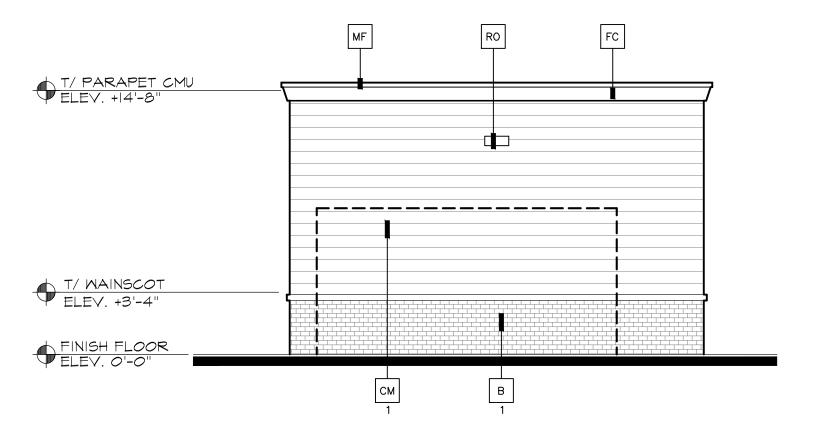


SOUTH ELEVATION
- SCALE: 3/16" = 1'-0"

EAST ELEVATION


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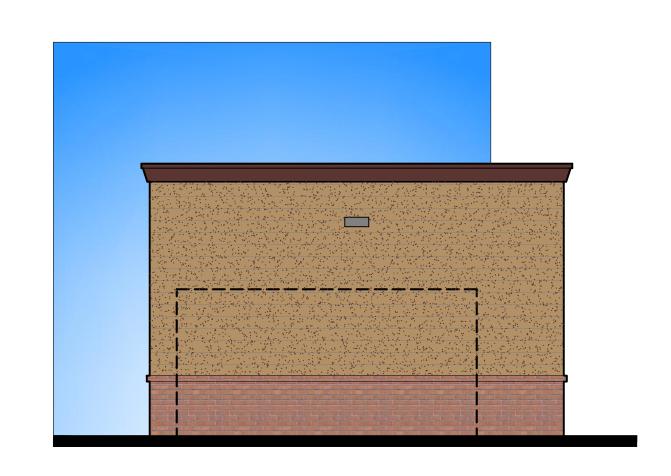
NORTH ELEVATION
SCALE: 3/16" = 1'-0"

4 WEST ELEVATION
- SCALE: 3/16" = 1'-0"



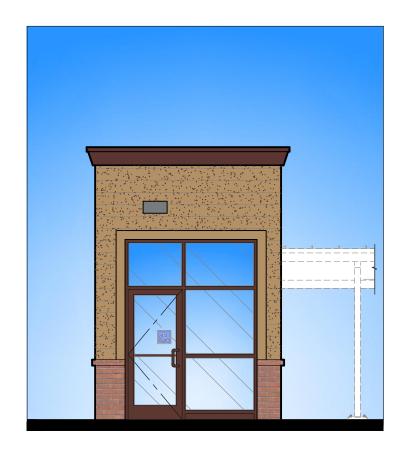



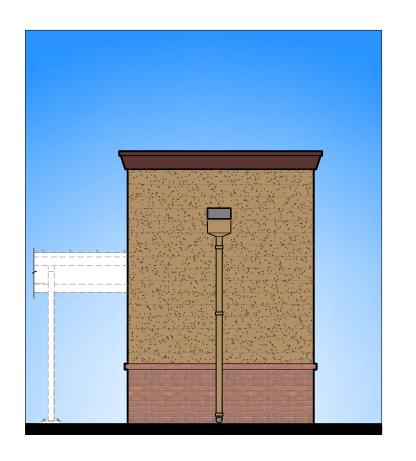

SOUTH ELEVATION
SCALE: 3/16" = 1'-0







KEY NOTES:

- THIN BRICK WAINSCOT. H. C. MUDDOX 1717 "SIERRA SLATE". THIN SET OVER CONCRETE MASONRY UNIT CONSTRUCTION. MORTAR COLOR MAPEI 39 "IVORY".
- BRICK VENEER SILL SHAPE. H.C. MUDDOX "SIERRA SLATE". MORTAR COLOR TO MATCH BRICK.
- ANGELUS BLOCK "PLACER CREEK BURNISHED" MEDIUM WEIGHT WITH INTEGRAL FACTORY "RAINBLOC" WATER REPELLENT ADMIXTURE. MORTAR TO HAVE "RAINBLOC" FOR MORTAR ADMIXTURE. GROUT BY SPEC MIX MORTOR #249.
- CP ACRYLIC PLASTER COLOR COAT
- COLOR DESIGNATION:
- PI = MATCH SHERWIN WILLIAMS #6123 "BAGUETTE" P2 = MATCH SHERWIN WILLIAMS #6374 "TORCHLIGHT"
- P3 = MATCH SHERWIN WILLIAMS #7004 "SNOWBOUND"
 P4 = MATCH SHERWIN WILLIAMS #6120 "BELIEVABLE BUFF"
 P5 = MATCH SHERWIN WILLIAMS #6034 "ARRESTING AUBURN"
- PLASTER COLOR COAT TO BE SAND FINISH
- CT 3" X 9 4" CEMENTITIOUS TRIM WITH RUSTIC FINISH.
 "HARDIE BOARD" OR EQUAL. PAINT SHERWIN WILLIAMS
 #6034 "ARRESTING AUBURN".
- HOLLOW METAL DOOR PAINT TO TO MATCH SHERWIN WILLIAMS #6123 "BAGUETTE"
- CLEAR ANODIZED ALUMINUM COMMERCIAL SLIDING GLASS DOOR

- OVERHEAD METAL DOOR PAINT TO TO MATCH SHERWIN WILLIAMS #7025 "BACKDROP"
- EJ 4" DEEP REVEAL EXPANSION JOINT

L4 = WALL PACK (DOWN ONLY)

- FC FOAM CORNICE WITH PLASTER FINISH COAT TO MATCH SHERWIN WILLIAMS #6034 "ARRESTING AUBURN"
- DECORATIVE IRON WORK RAILING SHERWIN WILLIAMS #3135P "NEW EBONY"
- LIGHT FIXTURE
 - LI = LED RADIAL WALL SCONCE (DOWN ONLY)
 L2 = LINEAR FACADE WALL LIGHT (DOWN ONLY)
 L3 = 2 FOOT LED PILASTER LIGHT (DOWN ONLY)
 - CONTACT STEVE FRIEDMAN 1.262.504.5479 WITH CREE LIGHTING FOR ORDERING LIGHTING. (NO EXCEPTIONS)

- METAL FASCIA PAINT SHERWIN WILLIAMS #6034
 "ARRESTING AUBURN"
- 6" PIPE BOLLARD FILLED WITH CONCRETE MATCH SHERWIN WILLIAMS #6374 "TORCHLIGHT".
- 2" WIDE X 1/4" DEEP ALUMINUM PLASTER REVEAL PAINT TO MATCH "6034 ARRESTING AUBURN"
- RF METAL ROOF FASCIA MATCH SHERMAN WILLIAMS #6034 "ARRESTING AUBURN"
- ROOF OVERFLOW SCUPPER PAINT TO MATCH ADJACENT FINISH
- SIGNAGE BY OTHERS SHOWN DASHED- FOR REFERENCE ONLY UNDER SEPARATE PERMIT. GENERAL CONTRACTOR TO COORDINATE WITH SIGN COMPANY.
- SS STANDING SEAM METAL ROOF FIRESTONE UC3 "BRANDY WINE".

- METAL WALL CANOPY SYSTEM COLOR TO MATCH SHERWIN WILLIAMS #6055 "FIERY BROWN"
- MALL CANOPY TIE-BACK SYSTEM COLOR SHERWIN WILLIAMS #3135P "NEW EBONY"
- 24" WIDE X 16" HIGH VENT PAINT TO MATCH ADJACENT FINISH
- W1 EXTERIOR WINDOW ASSEMBLY TEMPERED GLASS DARK BRONZE ANODIZED ALUMINUM STOREFRONT
- FAUX WINDOW ASSEMBLY TEMPERED SPANDREL GLASS DARK BRONZE ANODIZED ALUMINUM STOREFRONT



OWNER -



Quick Quack

1380 LEAD HILL BLVD #260 ROSEVILLE CA 95661 (916) 846-2100

PROJECT NAME:
QUICK QUACK CARWASH
SIERRA COLLEGE
ROCKLIN, CA. 95677
QQ# 6-021


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QUARTERBACK EXTERIOR ELEVATIONS

DRAWING DATE: SEPTEMBER 29, 2017

PLANNING DOCUMENTS

DRAWING NUMBER

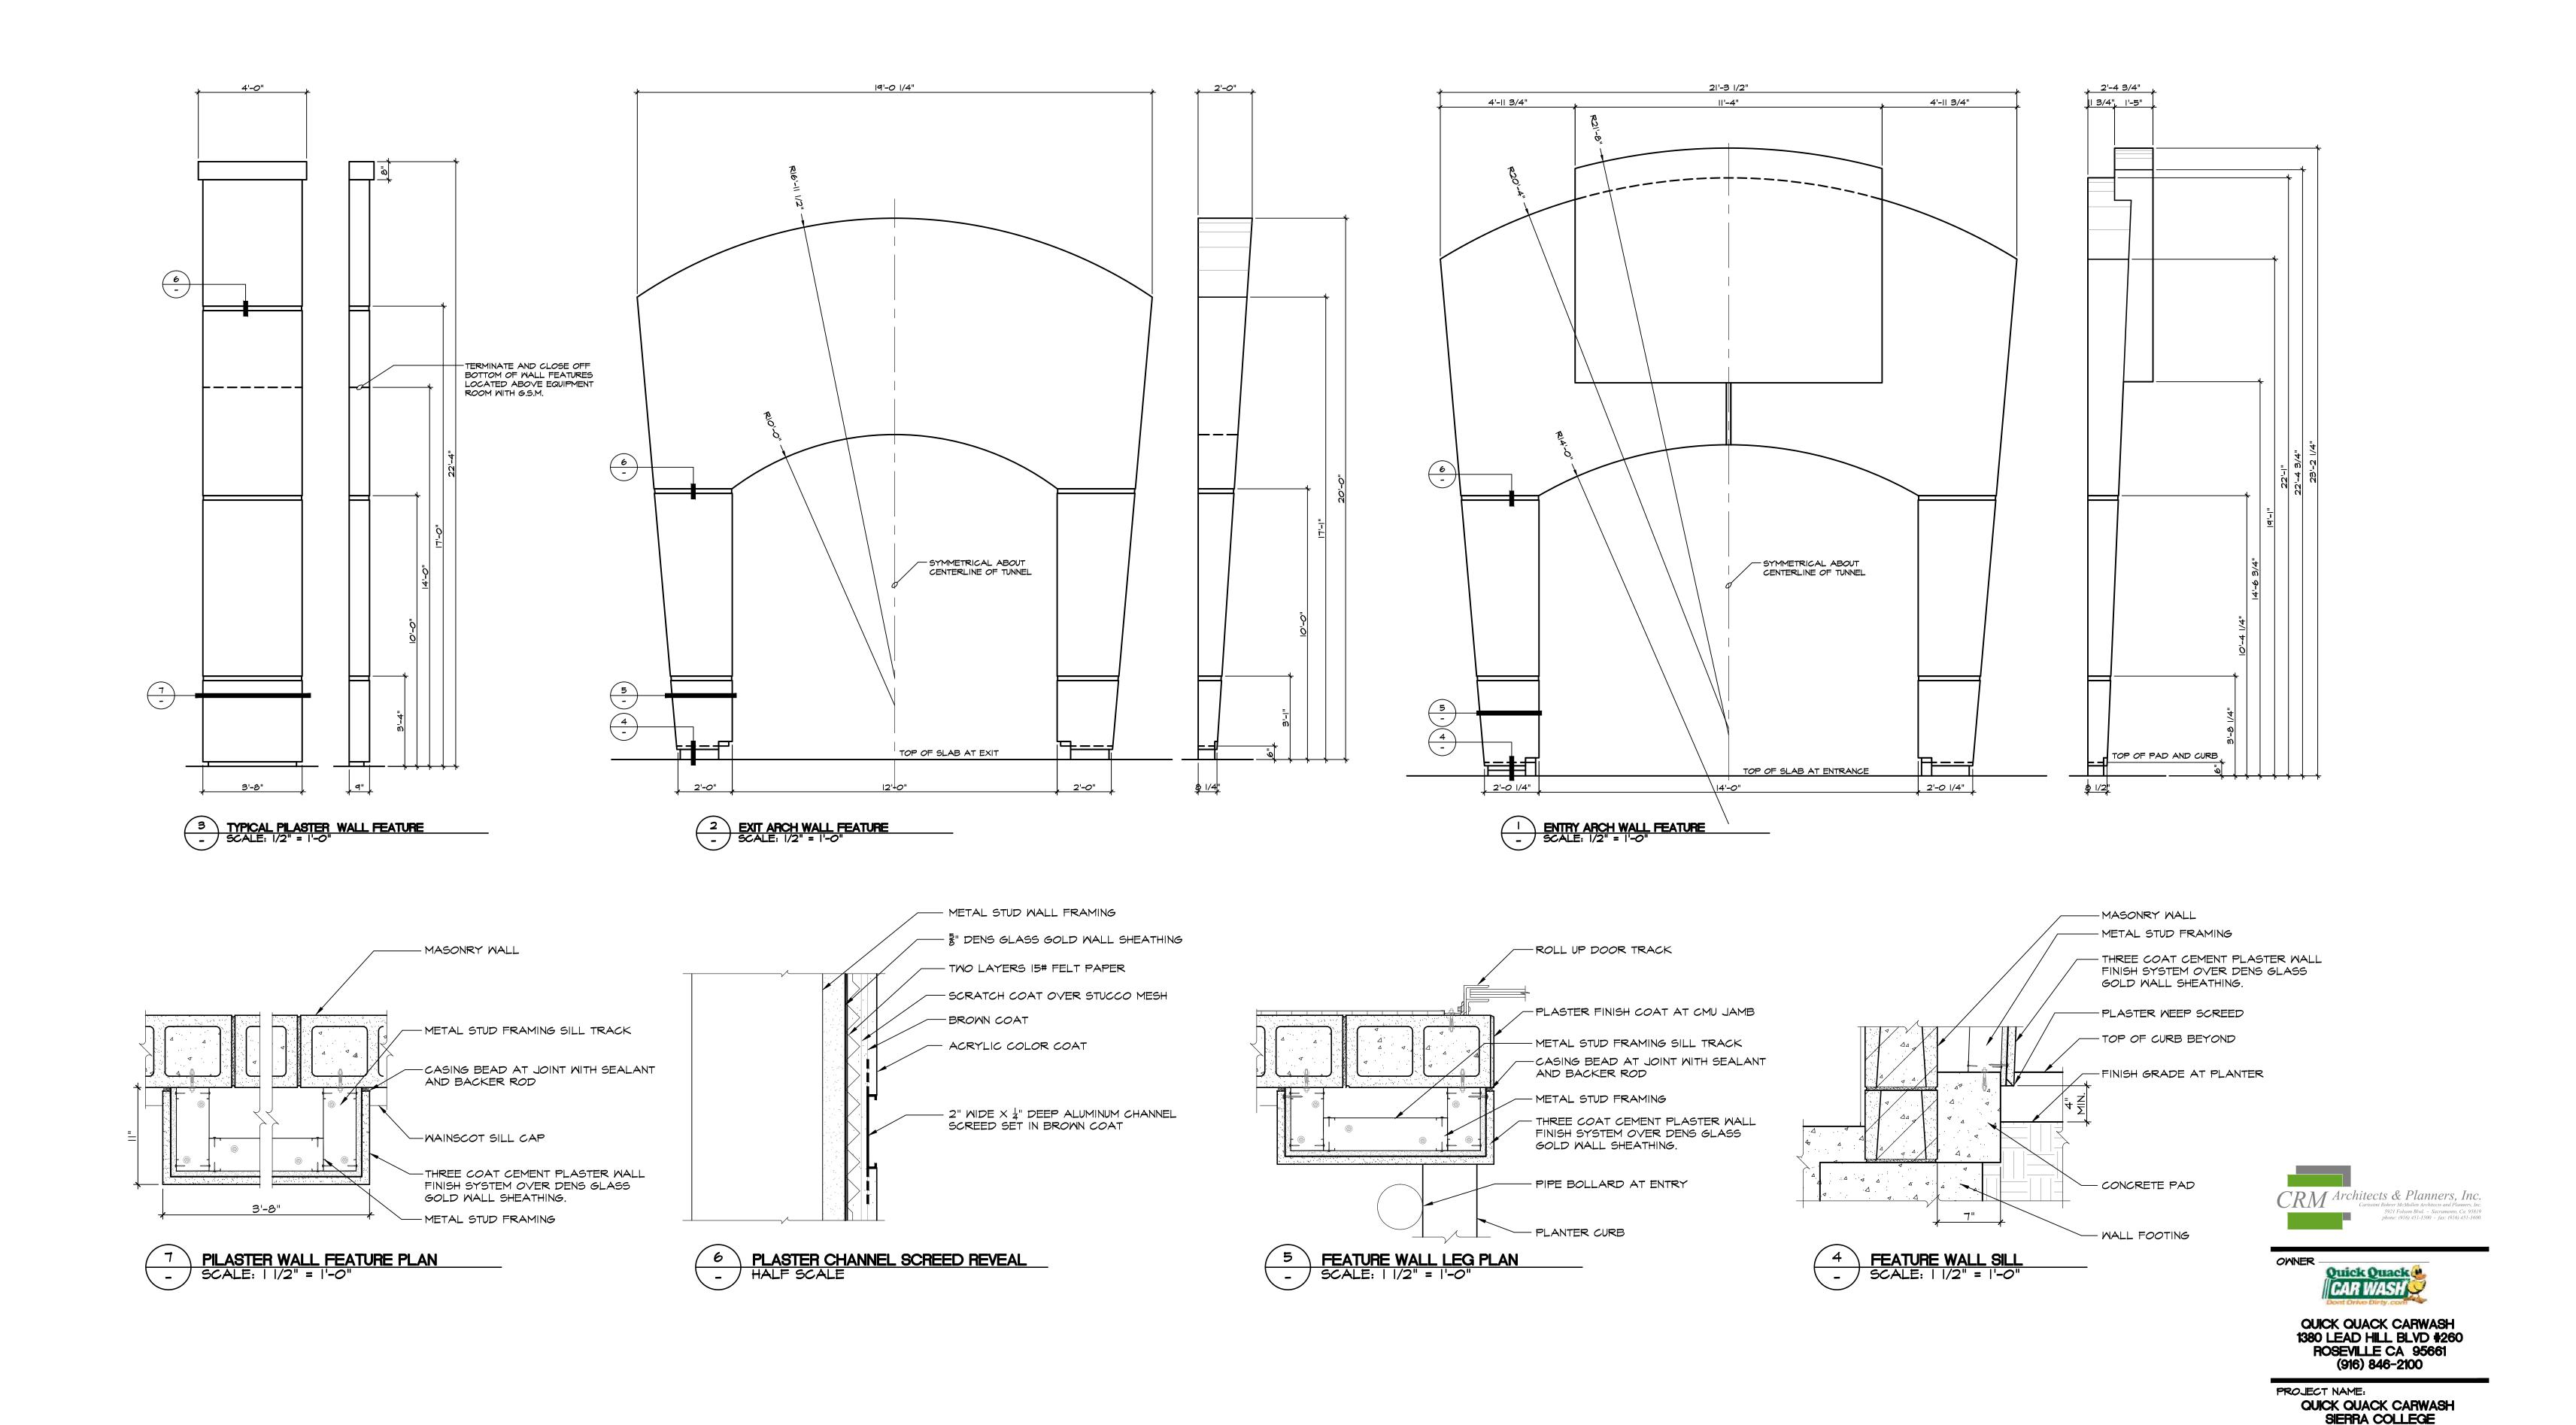

DRAWING DATE: SEPTEMBER 29, 2017

ROCKLIN, CA. 95677 QQ# 6-021


WALL FEATURE **ELEVATIONS**


PLANNING DOCUMENTS DRAWING NUMBER

DRAWING TITLE:



900TH ELEVATION
- SCALE: 3/16" = 1'-0

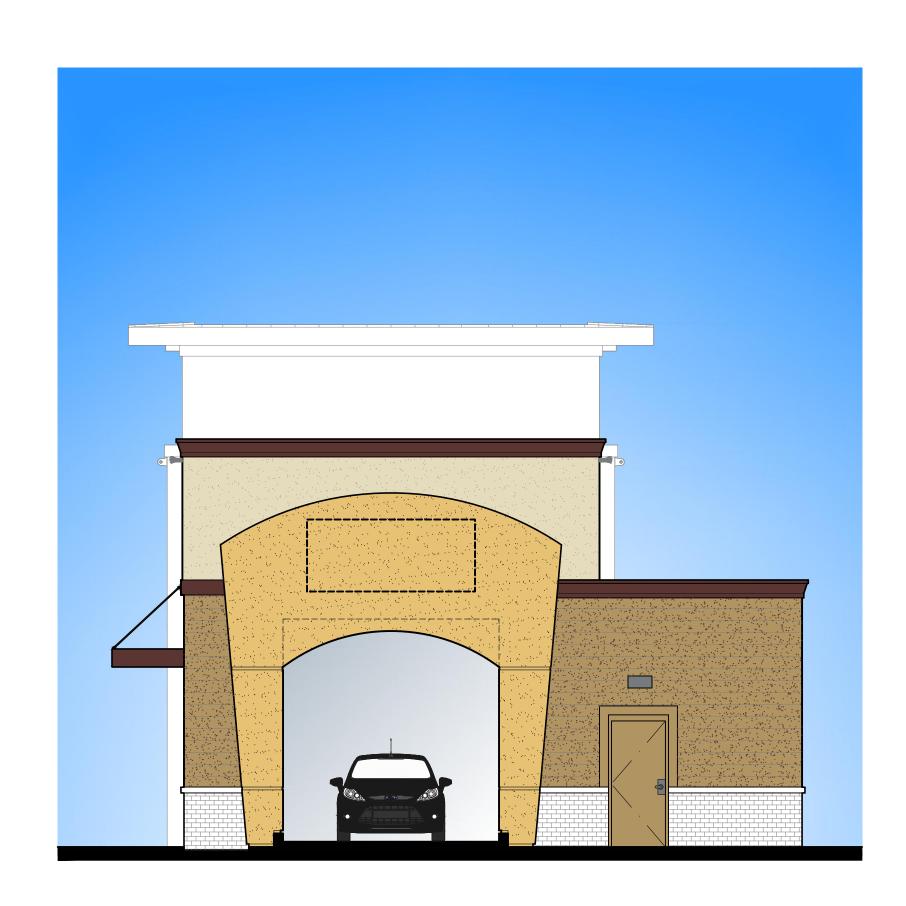

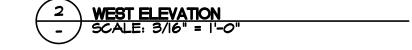



OWNER



QUICK QUACK CARWASH 1380 LEAD HILL BLVD #260 ROSEVILLE CA 95661 (916) 846-2100

PROJECT NAME:

OUICK QUACK CARWASH

SIERRA COLLEGE

ROCKLIN, CA. 95677

QO# 6-021

DRAWING TITLE:

COLOR ELEVATIONS

DRAWING DATE: SEPTEMBER 29, 2017


PLANNING DOCUMENTS

DRAWING NUMBER



NORTH ELEVATION

SCALE: 3/16" = 1'-0"

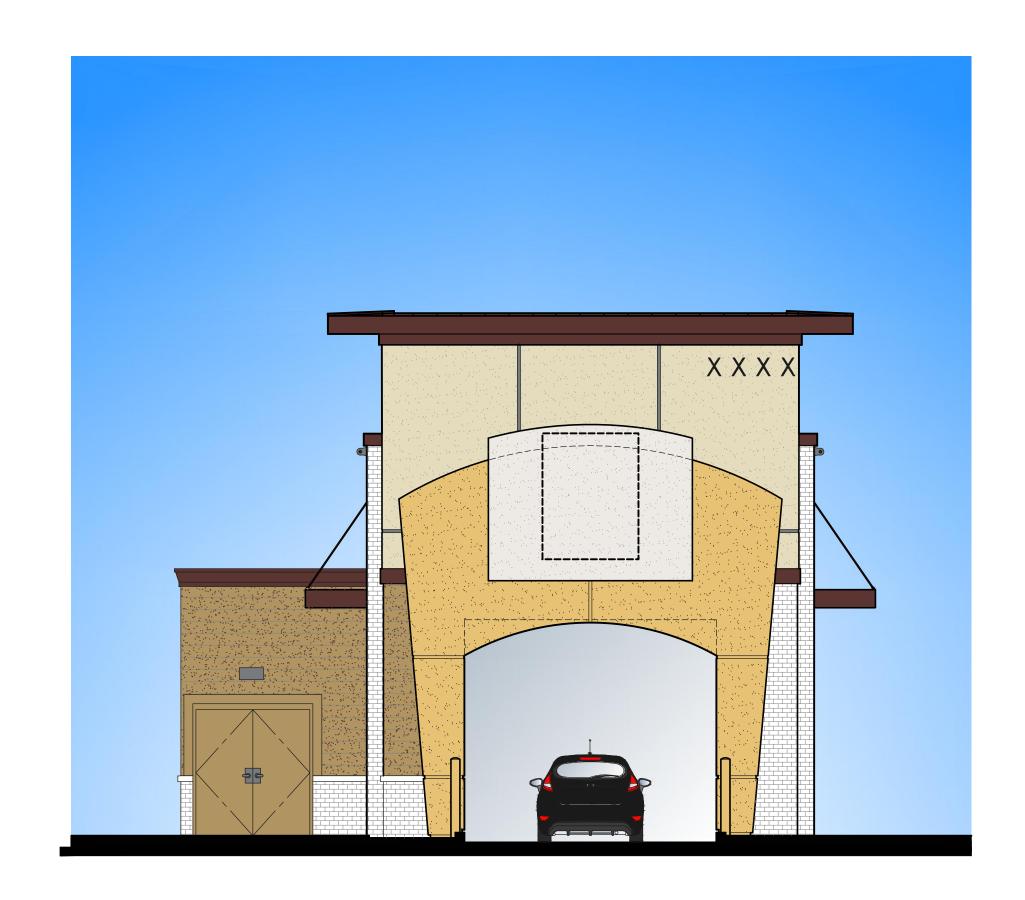

2 EAST ELEVATION - SCALE: 3/16" = 1'-0"



OWNER



QUICK QUACK CARWASH 1380 LEAD HILL BLVD #260 ROSEVILLE CA 95661 (916) 846-2100

PROJECT NAME:

OUICK QUACK CARWASH

SIERRA COLLEGE

ROCKLIN, CA. 95677

QO# 6-021


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COLOR ELEVATIONS

DRAWING DATE: SEPTEMBER 29, 2017

PLANNING DOCUMENTS


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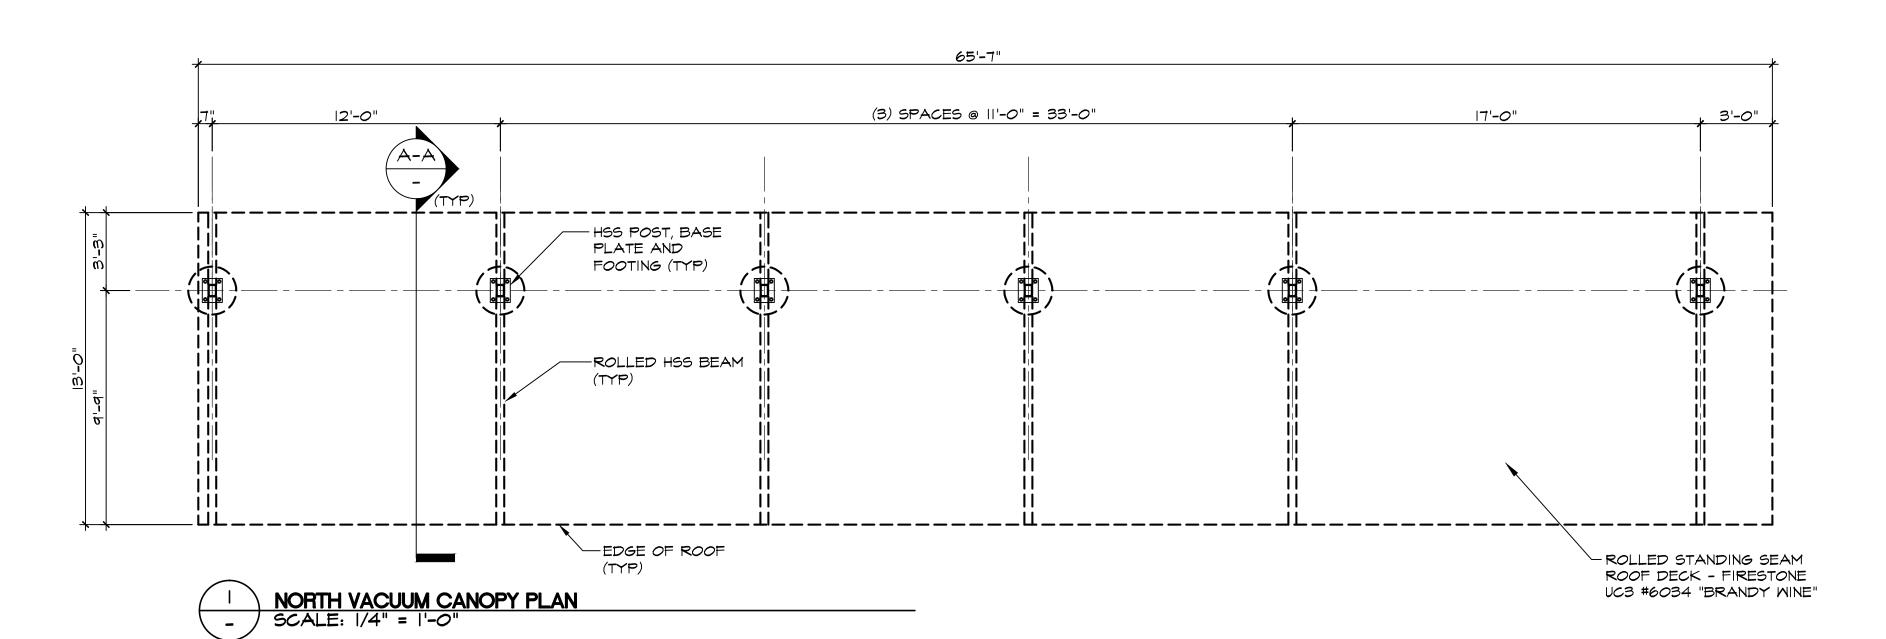


2 NORTH VACUUM CANOPY ELEVATION

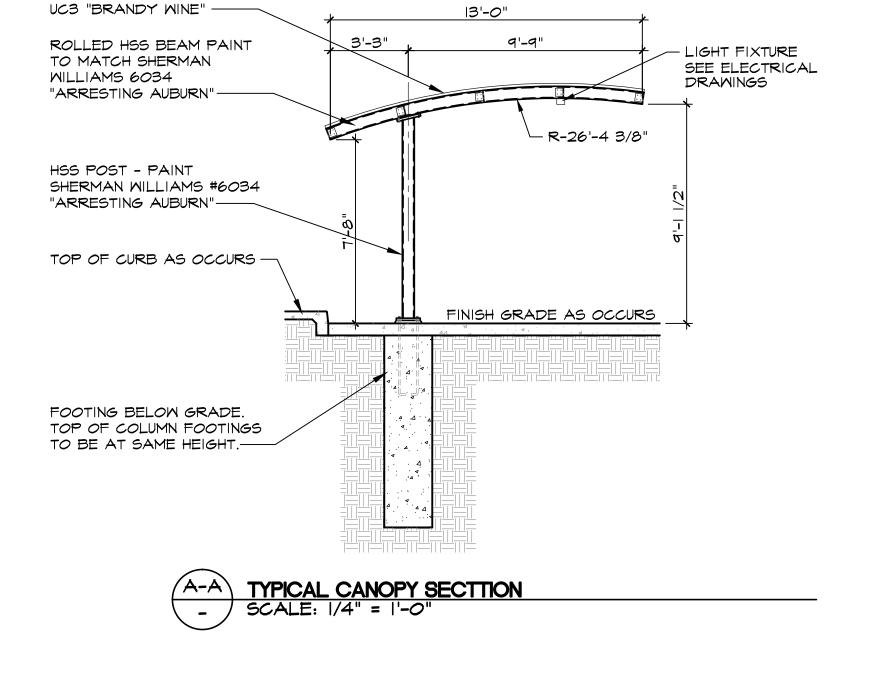- SCALE: |/4" = |'-0"

ROLLED STANDING SEAM ROOF DECK - FIRESTONE



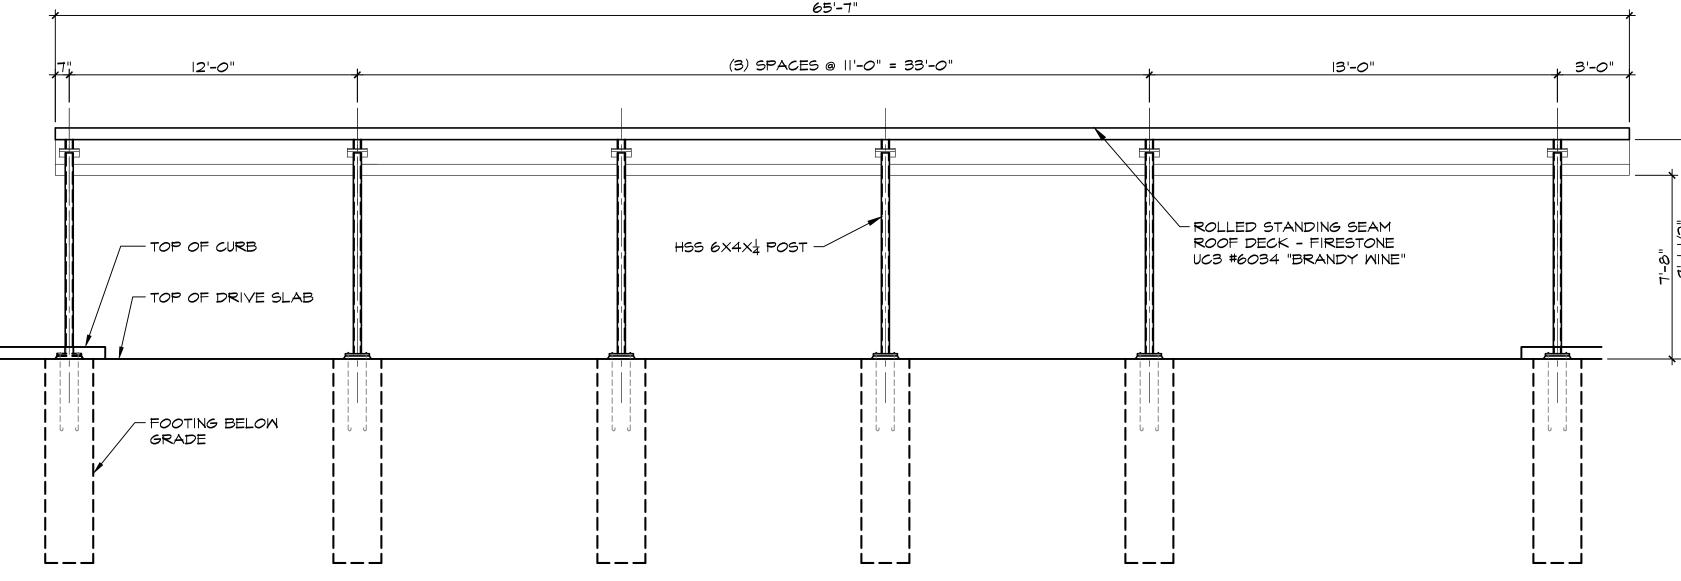



OWNER



QUICK QUACK CARWASH 1380 LEAD HILL BLVD #260 ROSEVILLE CA 95661 (916) 846-2100

PROJECT NAME:

QUICK QUACK CARWASH
SIERRA COLLEGE
ROCKLIN, CA. 95677
QQ# 6-021


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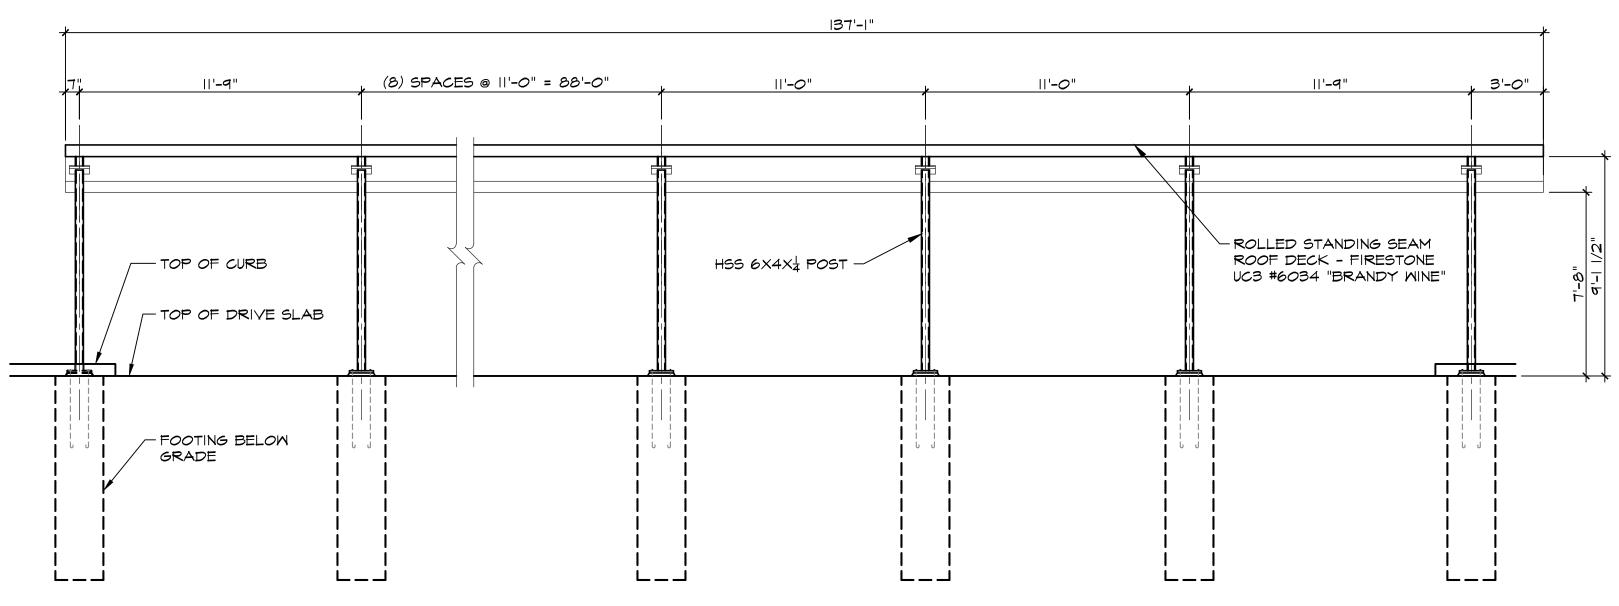
NORTH CANOPY PLAN

DRAWING DATE: SEPTEMBER 29, 2017


PLANNING DOCUMENTS

DRAWING NUMBER



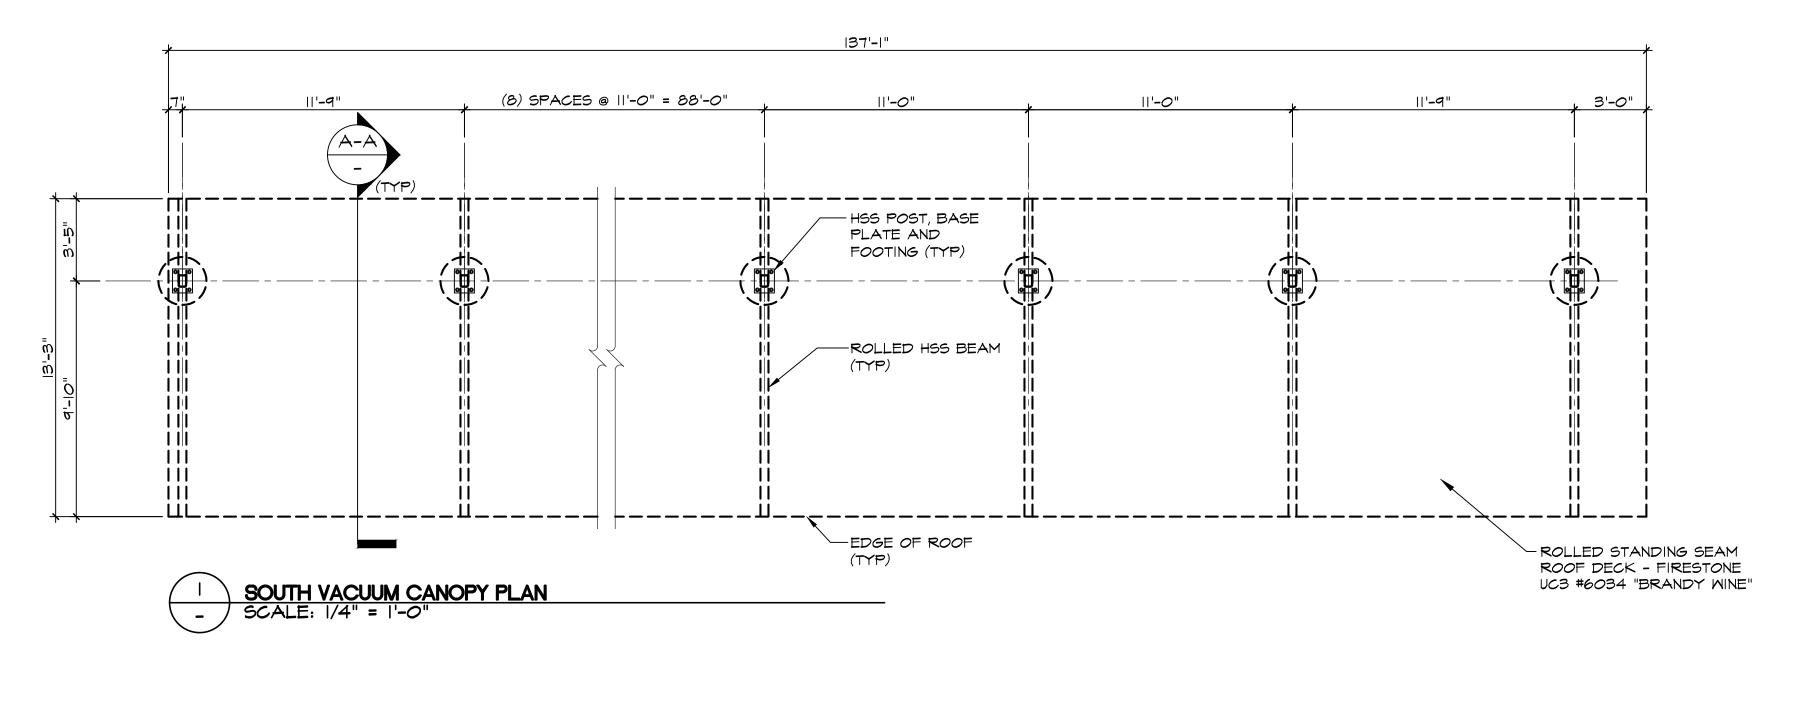



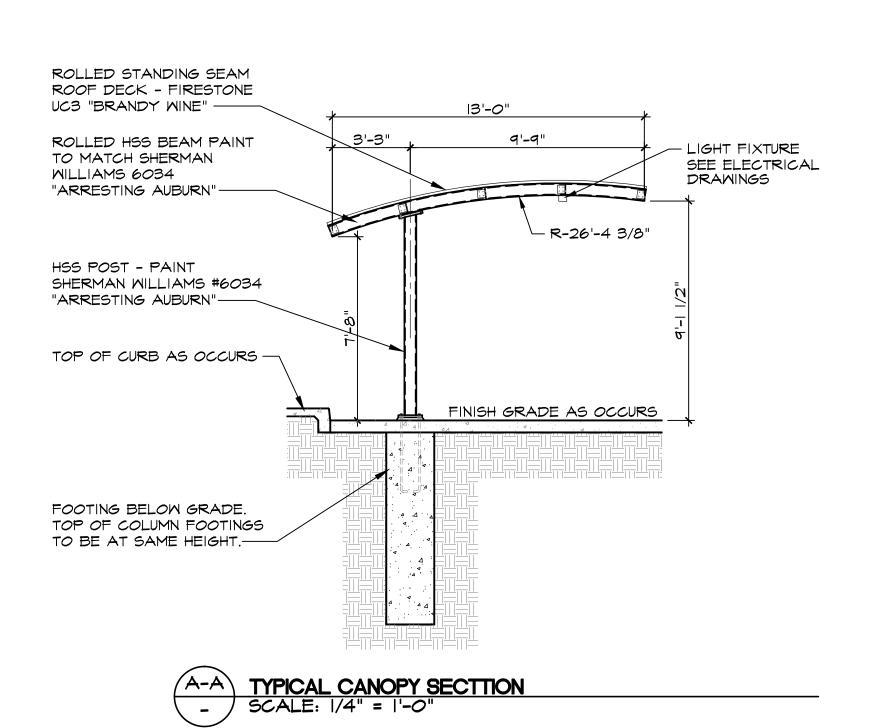



OWNER



QUICK QUACK CARWASH 1380 LEAD HILL BLVD #260 ROSEVILLE CA 95661 (916) 846-2100

PROJECT NAME:

QUICK QUACK CARWASH
SIERRA COLLEGE
ROCKLIN, CA. 95677
QQ# 6-021


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SOUTH CANOPY PLAN

DRAWING DATE: SEPTEMBER 29, 2017


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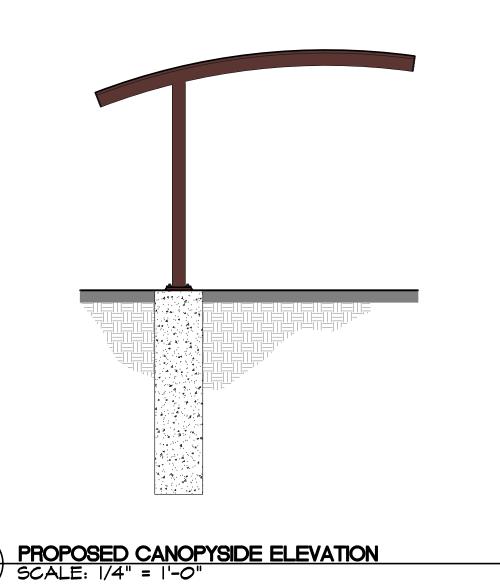
NORTH VACUUM CANOPY PLAN

SCALE: 1/4" = 1'-0"

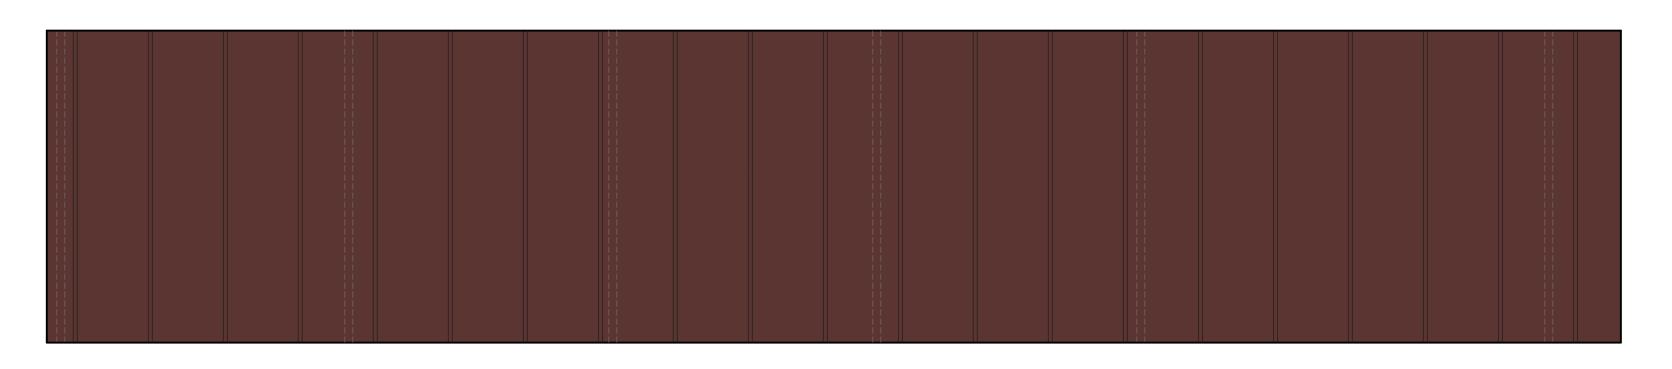

2 NORTH VACUUM CANOPY ELEVATION

SCALE: 1/4" = 1'-0"

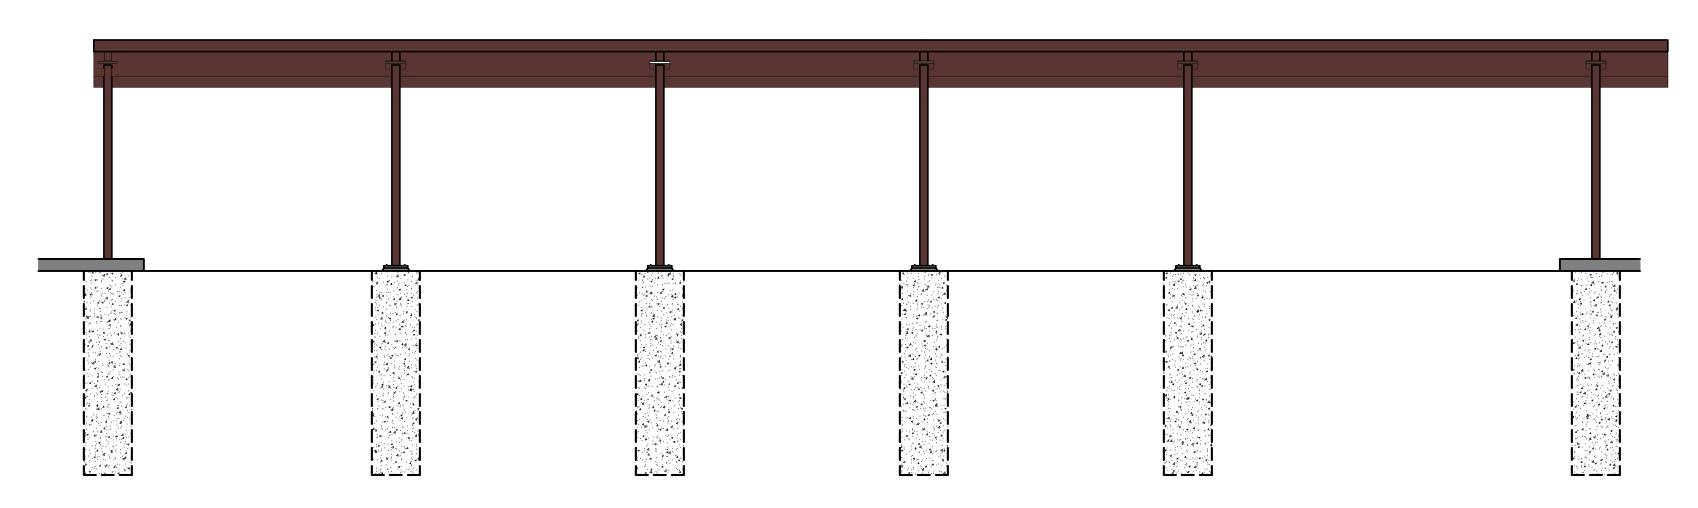



OWNER -



QUICK QUACK CARWASH 1380 LEAD HILL BLVD #260 ROSEVILLE CA 95661 (916) 846-2100

PROJECT NAME:

QUICK QUACK CARWASH

SIERRA COLLEGE

ROCKLIN, CA. 95677

QO# 6-021


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NORTH CANOPY COLOR PLAN

DRAWING DATE: SEPTEMBER 29, 2017


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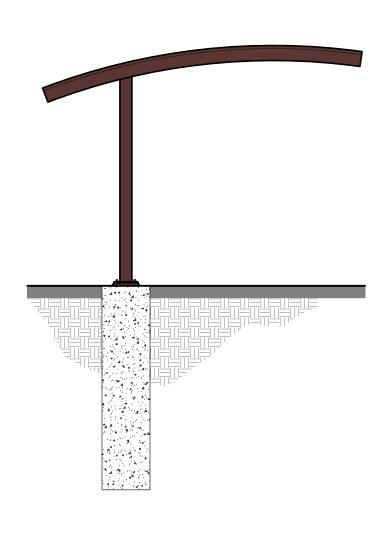


SOUTH VACUUM CANOPY PLAN

SCALE: |/4" = |'-0"

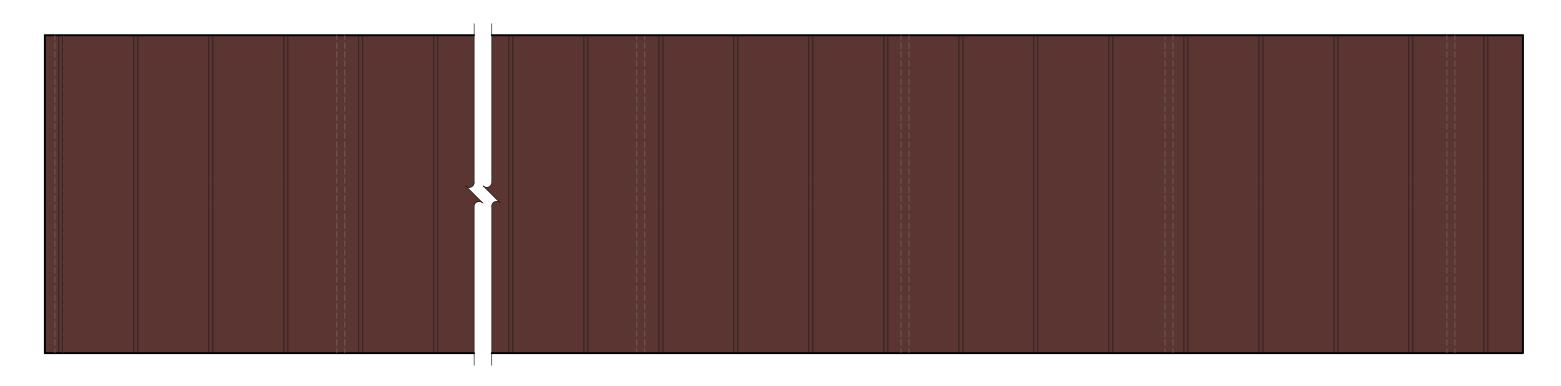

2 SOUTH VACUUM CANOPY ELEVATION
- SCALE: 1/4" = 1'-0"

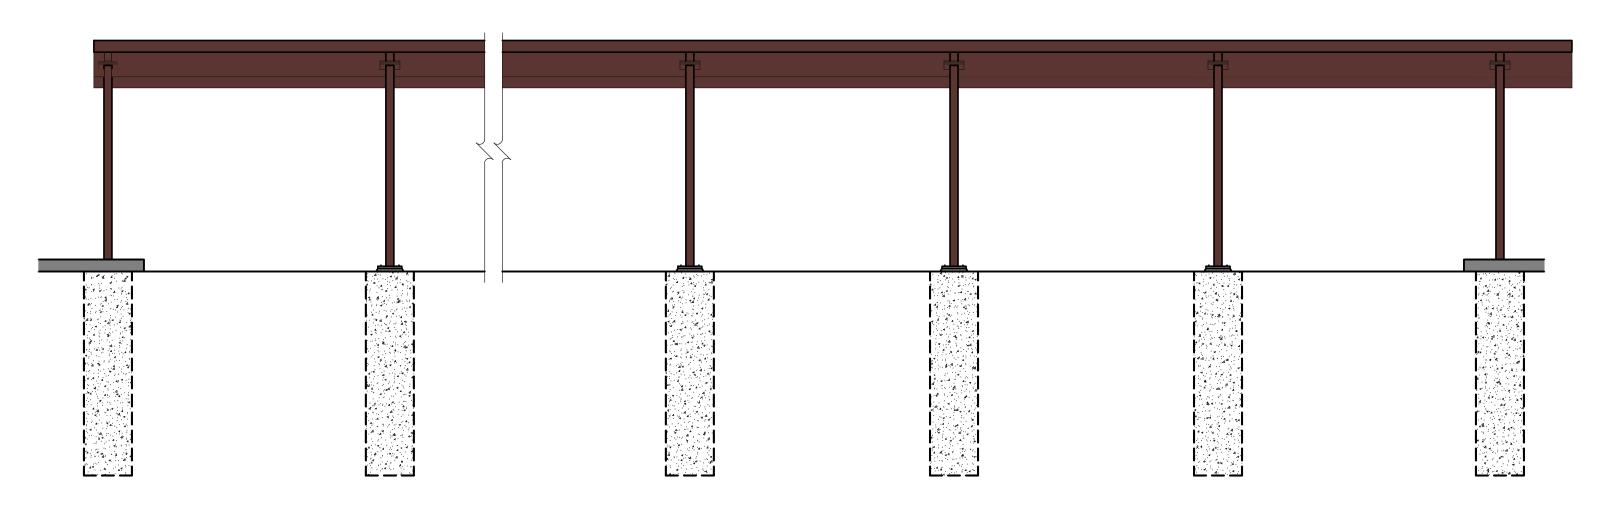

PROPOSED CANOPY SIDE ELEVATION

SCALE: |/4" = |'-0"



OWNER -



QUICK QUACK CARWASH 1380 LEAD HILL BLVD #260 ROSEVILLE CA 95661 (916) 846-2100

PROJECT NAME:

OUICK QUACK CARWASH

SIERRA COLLEGE

ROCKLIN, CA. 95677

OO# 6-021


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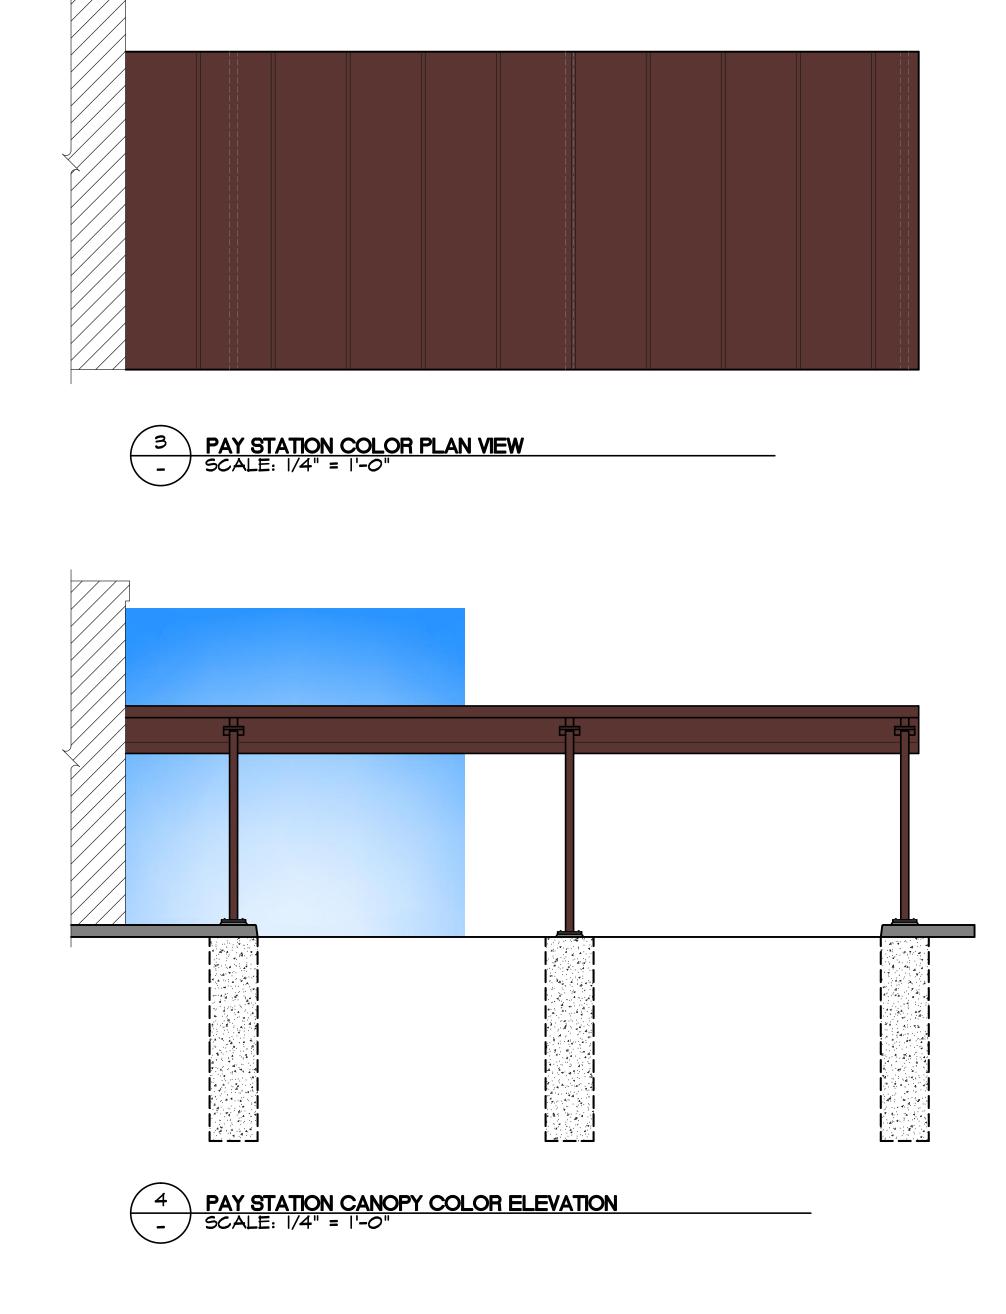
SOUTH CANOPY COLOR PLAN


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PLANNING DOCUMENTS

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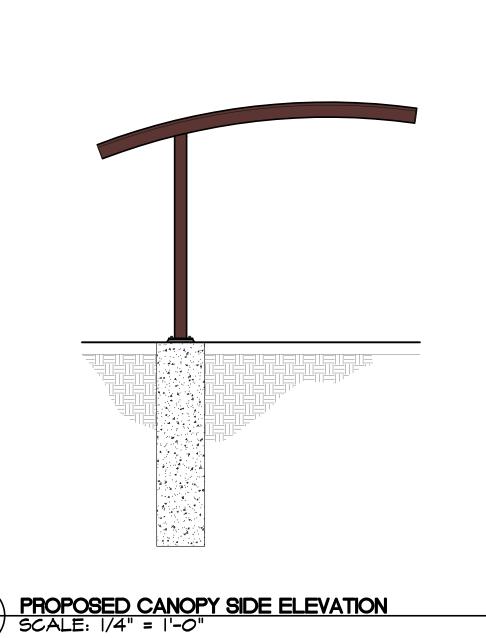


PAY STATION CANOPY ELEVATION

SCALE: |/4" = |'-0"

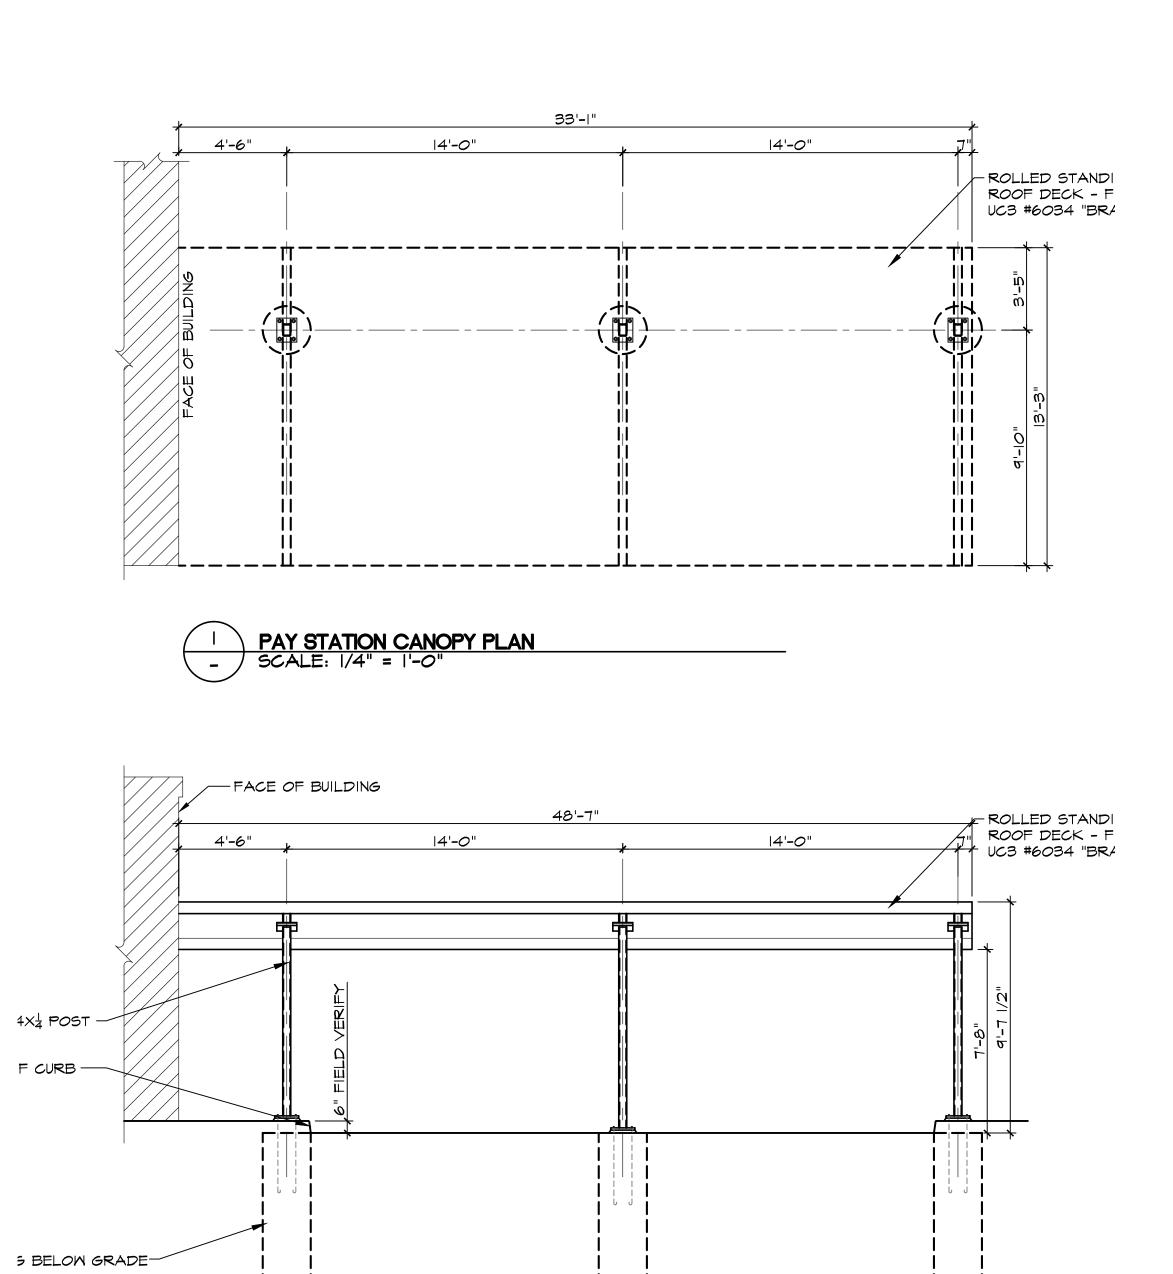4X4 POST -

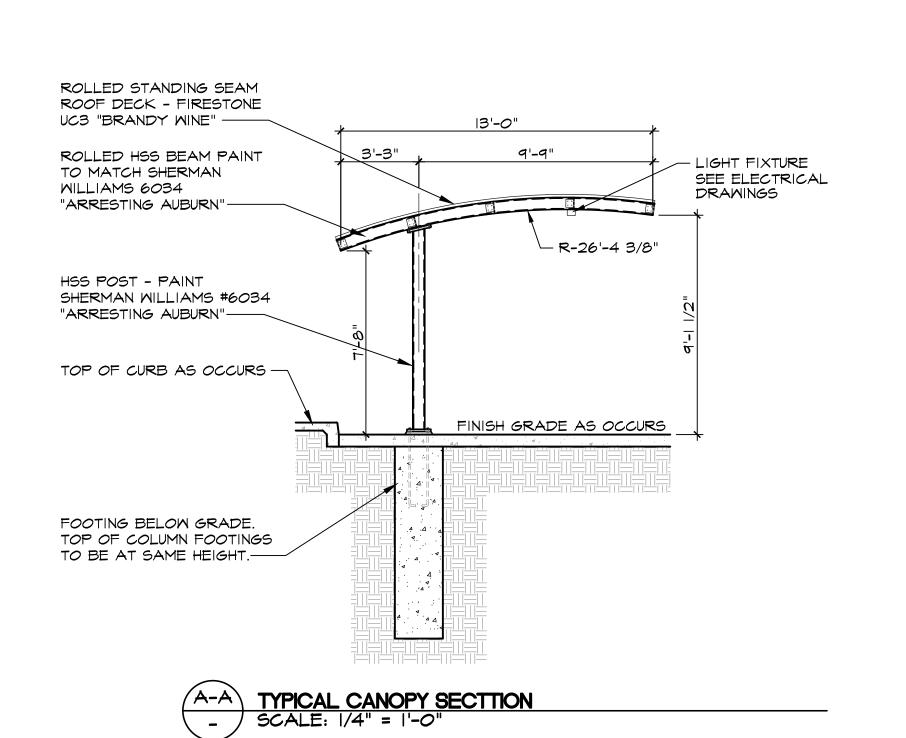F CURB -







QUICK QUACK CARWASH 1380 LEAD HILL BLVD #260 ROSEVILLE CA 95661 (916) 846-2100

PROJECT NAME: QUICK QUACK CARWASH SIERRA COLLEGE ROCKLIN, CA. 95677 QQ# 6-021


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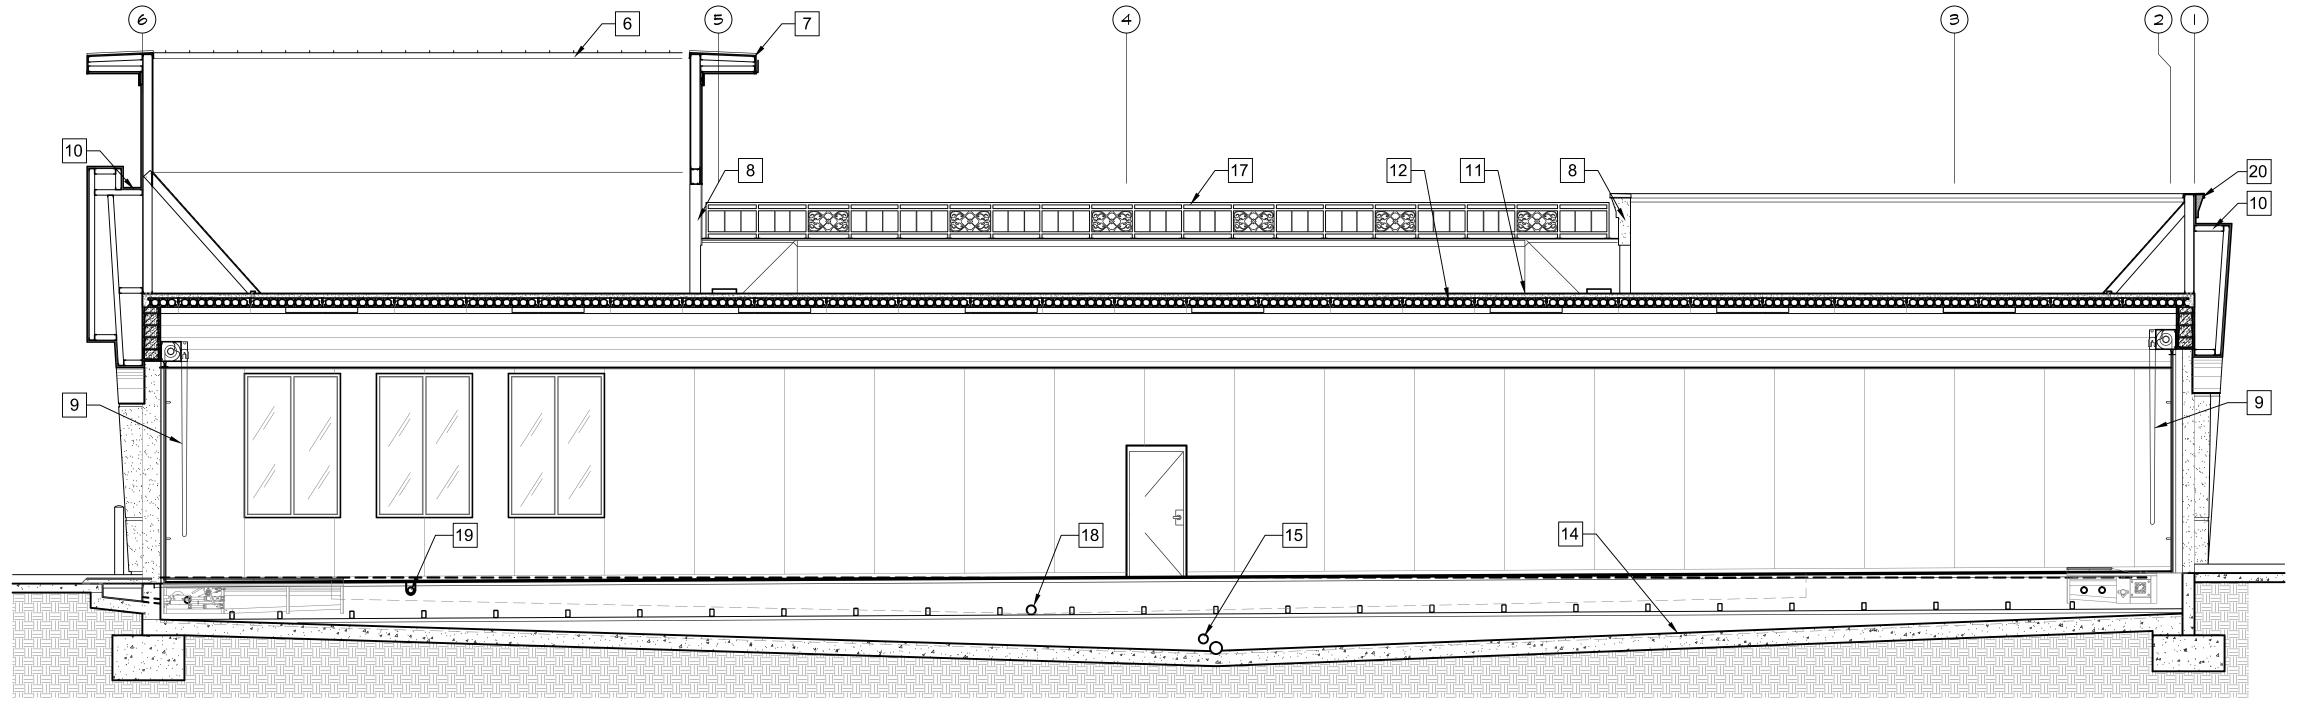
PAY CANOPY PLAN


DRAWING DATE: SEPTEMBER 29, 2017

PLANNING DOCUMENTS

DRAWING NUMBER



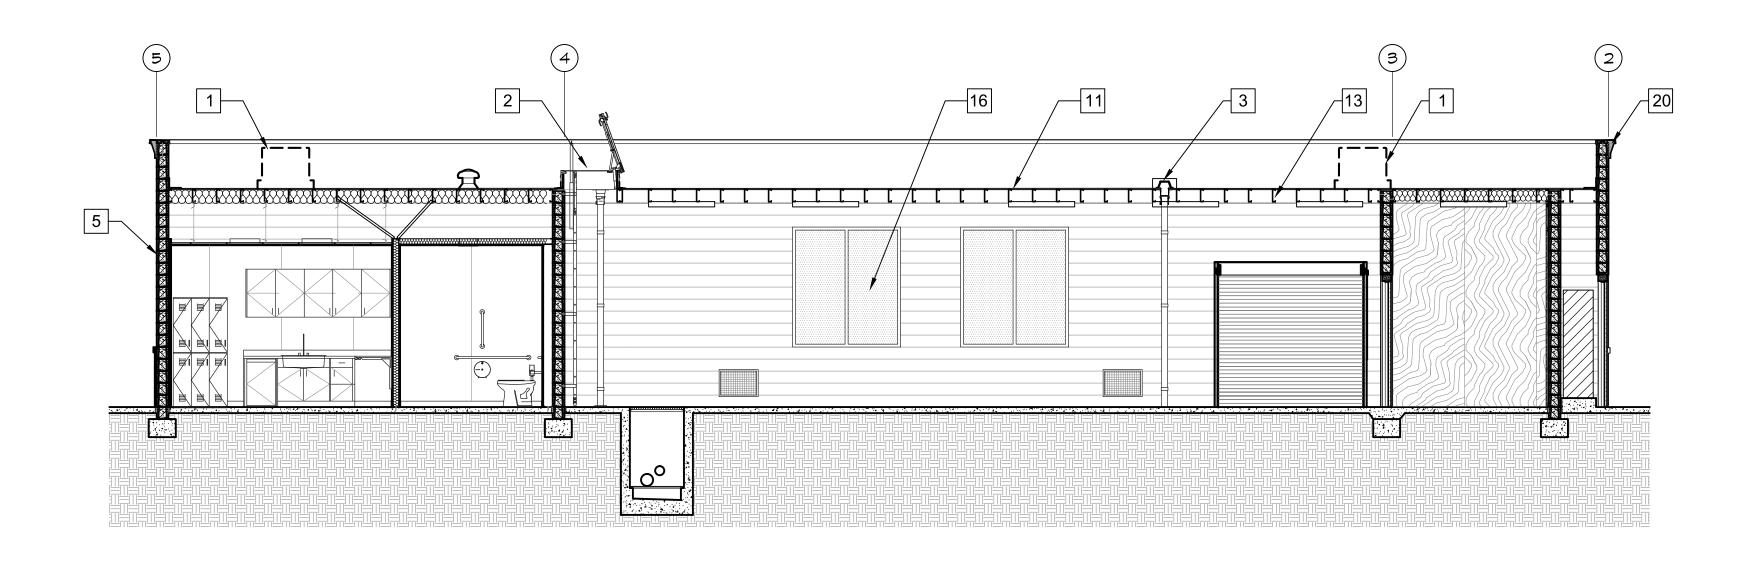

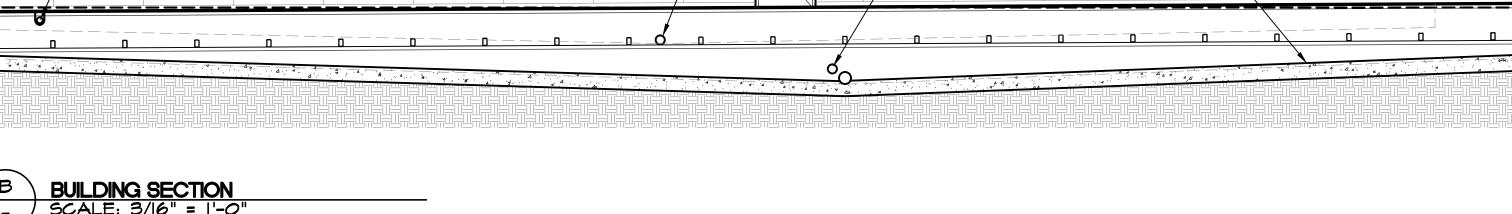



- 1 ROOF TOP MECHANICAL UNIT IN FOREGROUND SHOWN DASHED. CONCEALED FROM VIEW BEHIND PARAPET WALL.
- 2 ROOF ACCESS HATCH.
- 3 ROOF DRAIN AND OVERFLOW SCUPPER.
- 4 ELECTRICAL SERVICE SMITCHGEAR ON HOUSEKEEPING PAD.
- 5 CONCRETE MASONRY UNIT WALL CONSTRUCTION.
- 6 OPEN TO ROOF BELOW.
- 7 STANDING SEAM METAL ROOFING AT PERIMETER OVERHANG.
- 8 OPENING IN WALL.
- 9 COILING ROLL-UP DOOR
- 10 METAL STUD FRAMED WALL FEATURE WITH CEMENT PLASTER WALL FINISH.
- 11 TPO MEMBRANE ROOFING.
- 12 HOLLOW CORE PRE-CAST PLANK ROOF STRUCTURE.
- 13 METAL STUD ROOF FRAMING.
- 14 CONVEYOR TRENCH. SLOPE TO DRAIN.
- 15 CONVEYOR TRENCH DRAIN AND OVERFLOW.
- 16 FAUX WINDOWS SEE WINDOW ELEVATIONS.
- 17 DECORATIVE METAL RAILING
- 18 UTILITY TRENCH DRAIN OUTLET.
- 19 PIPE CHASE FROM UTILITY TRENCH (TYP).
- 20 FOAM CORNICE





QUICK QUACK CARWASH 1380 LEAD HILL BLVD #260 ROSEVILLE CA 95661 (916) 846-2100

PROJECT NAME: QUICK QUACK CARWASH SIERRA COLLEGE ROCKLIN, CA. 95677 QQ# 6-021

DRAWING TITLE:


BUILDING SECTIONS


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PLANNING DOCUMENTS


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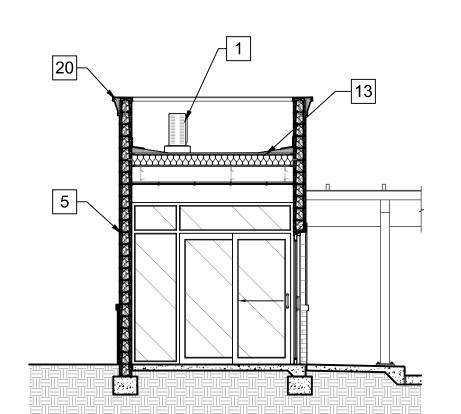






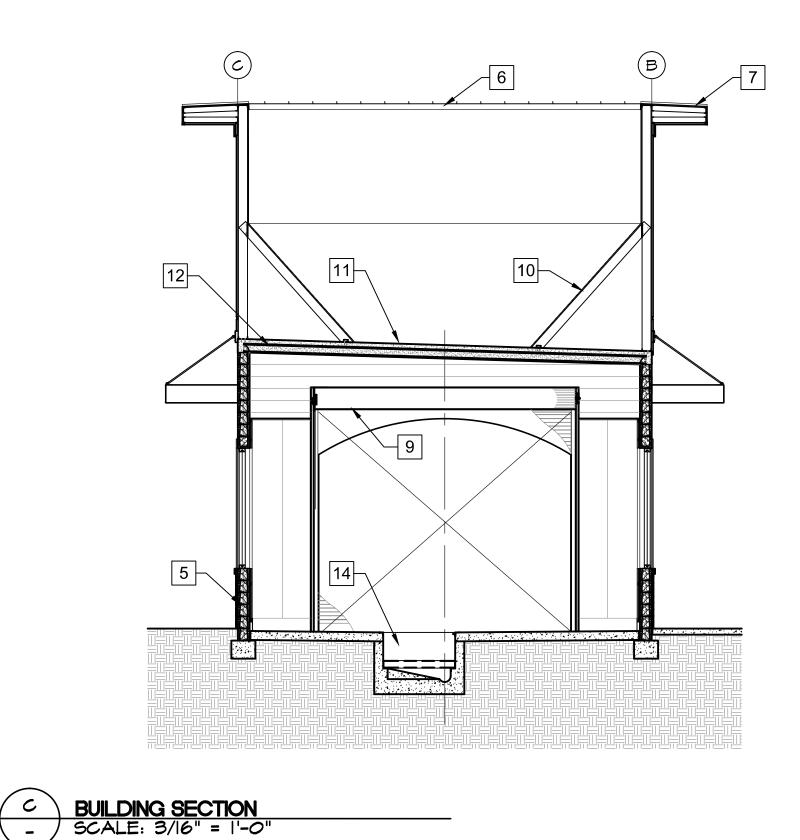

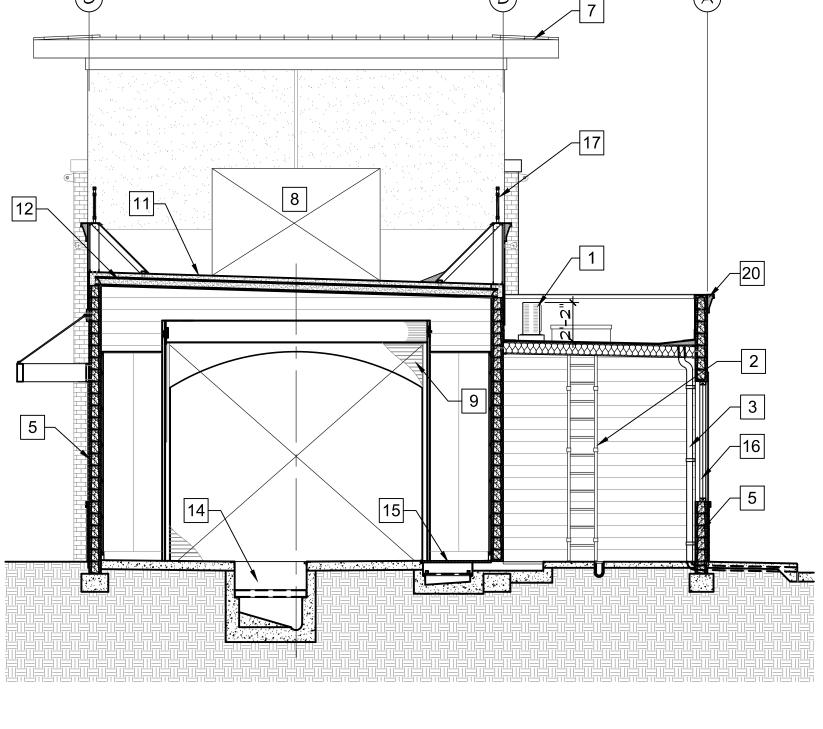

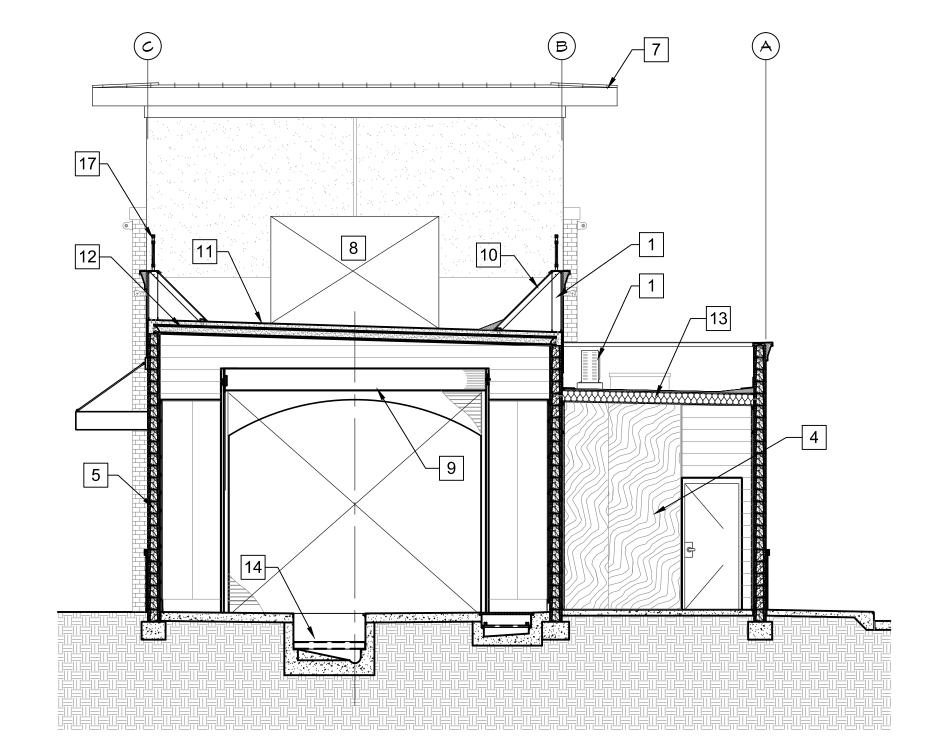



KEYNOTES

- 1 ROOF TOP MECHANICAL UNIT. CONCEALED FROM VIEW BEHIND PARAPET WALL.
- 2 ROOF ACCESS LADDER.
- 3 ROOF DRAIN PIPE. SEE PLUMBING DRAWINGS.
- 4 ELECTRICAL ROOM PLYWOOD EQUIPMENT MOUNTING BACKBOARD.
- 5 CONCRETE MASONRY UNIT WALL CONSTRUCTION.
- 6 OPEN TO ROOF BELOW.
- 7 STANDING SEAM METAL ROOFING AT PERIMETER OVERHANG.
- 8 OPENING IN WALL.
- 9 COILING ROLL-UP DOOR
- 10 METAL STUD DIAGONAL BRACE PLYWOOD CRICKET.
- 11 TPO MEMBRANE ROOFING.
- 12 HOLLOW CORE PRE-CAST PLANK ROOF STRUCTURE.
- 13 METAL STUD ROOF FRAMING.
- 14 CONVEYOR TRENCH. SLOPE TO DRAIN.
- 15 UTILITY TRENCH.
- 16 SPANDREL GLASS WINDOW IN STOREFRONT FRAME.
- 17 DECORATIVE METAL RAILING
- 18 UTILITY TRENCH DRAIN OUTLET.
- 19 PIPE CHASE FROM UTILITY TRENCH (TYP).
- 20 FOAM CORNICE



Ouick Quack

QUICK QUACK CARWASH 1380 LEAD HILL BLVD #260 ROSEVILLE CA 95661 (916) 846-2100

PROJECT NAME:
QUICK QUACK CARWASH
SIERRA COLLEGE
ROCKLIN, CA. 95677
QQ# 6-021

DRAWING TITLE:

BUILDING SECTIONS


DRAWING DATE: SEPTEMBER 29, 2017

PLANNING DOCUMENTS

DRAWING NUMBER

A6.2

NOTE: Renderings below utilize sample dimensions.

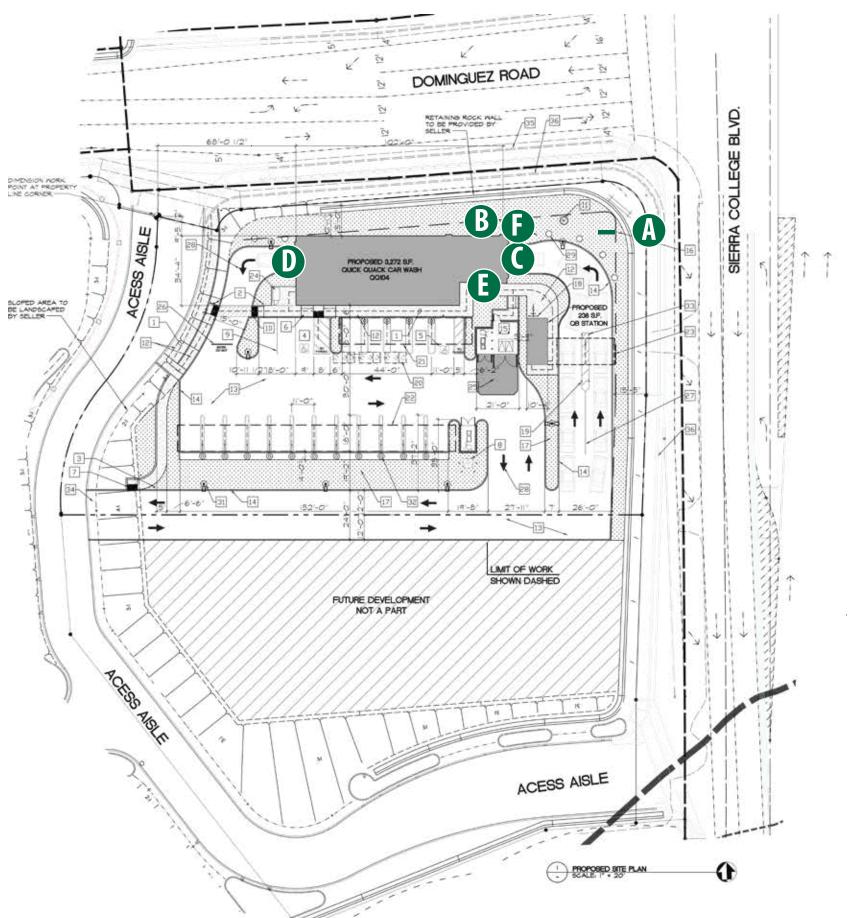



3750 East Outer Drive Detroit, MI 48234

t: 313.368.4000 f: 313.368.9335

www.fairmontsign.com



Quick Quack Car Wash #6-021 Dominguez Rd & Sierra College Blvd Rocklin, CA

Date:

12/13/17

File:

Accounts/Misc/Quick Quack/Elev/ Rocklin, CA_Sierra College

Designer:

Scale:

Sheet# 00000 1 of 8

Revision #2

8-21-18

Revision Description:

Customer Approval:

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NOTE: Renderings below utilize sample dimensions.









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Quick Quack Car Wash #6-021 Dominguez Rd & Sierra College Blvd Rocklin, CA

Date:

12/13/17

| Fil

Accounts/Misc/Quick Quack/Elev/ Rocklin, CA_Sierra College

Designer:

Scale:

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Job#

Sheet# 00000 2 of 8

Revision #

Date: 8-21-18


Revision Description:

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t: 313.368.4000 f: 313.368.9335

Cliente



Quick Quack Car Wash #6-021 Dominguez Rd & Sierra College Blvd Rocklin, CA

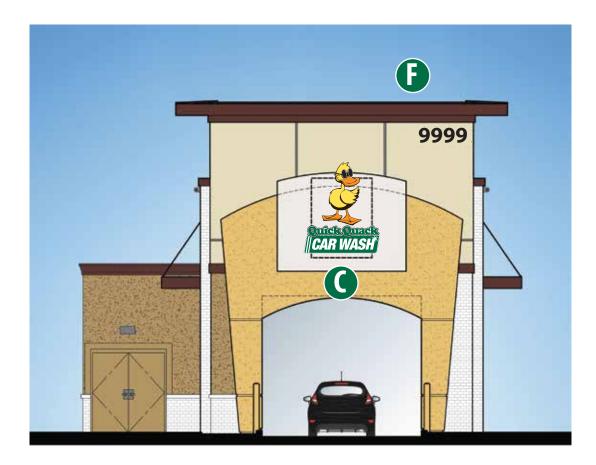Date:

12/13/17

File

Accounts/Misc/Quick Quack/Elev/ Rocklin, CA_Sierra College

Designer:

Scale:

NA

 Job#
 Sheet#

 00000
 3 of 8

 Revision #
 Date:

8-21-18


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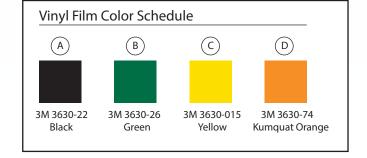
NOTE: Renderings below utilize sample dimensions.





Material Schedule

Fabricated aluminum, cloud-shaped channel construction. Face to be White acrylic with 3M vinyl film overlays (see color schedule). Returns and trimcap to be painted White. Cabinet to be internally illuminated with White LEDs.

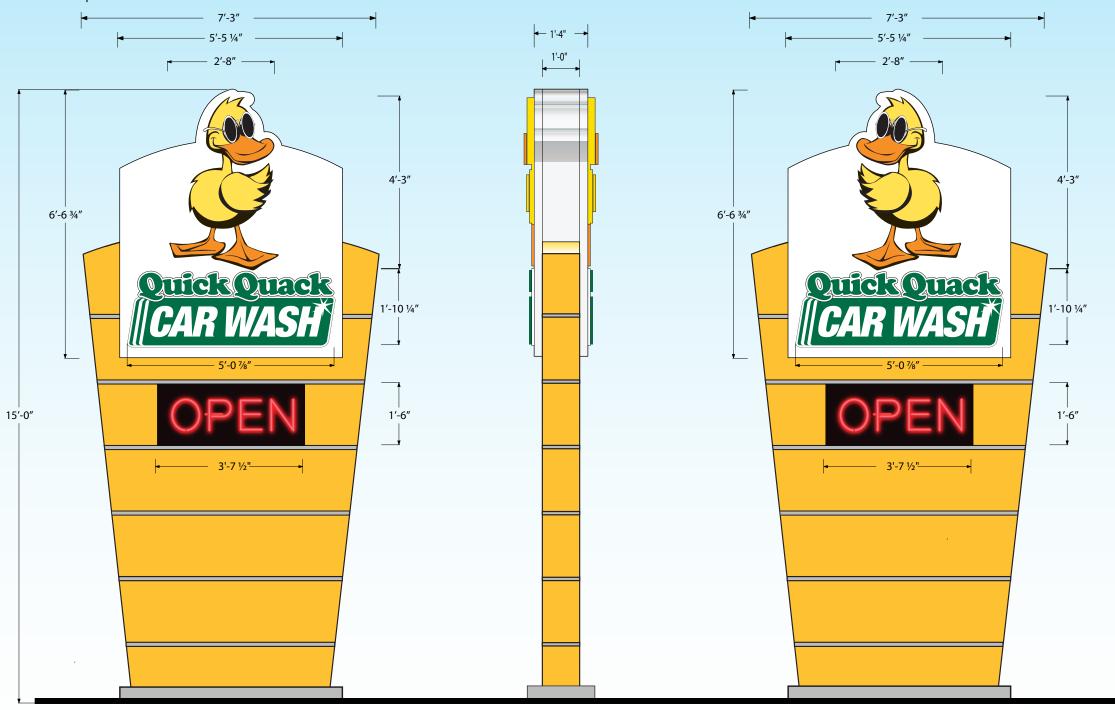



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Quick Quack Car Wash #6-021 Dominguez Rd & Sierra College Blvd Rocklin, CA

Date:

12/13/17

Accounts/Misc/Quick Quack/Elev/ Rocklin, CA_Sierra College

Designer:

Scale:

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Sheet# 00000 4 of 8

Revision #

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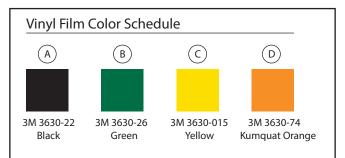




QTY 2: LED Illuminated Wall Signs

Background is opaque- only copy lights.

(99.6 SqFt)





Material Schedule

Fabricated aluminum, cloud-shaped channel construction. Face to be White acrylic with 3M vinyl film overlays (see color schedule). Returns and trimcap to be painted White. Cabinet to be internally illuminated with White LEDs.



THREE DIMENSIONAL CONTOURED FACE W/ OPAQUE BACKGROUND PROVIDES AN INDIVIDUAL LETTER APPEARANCE

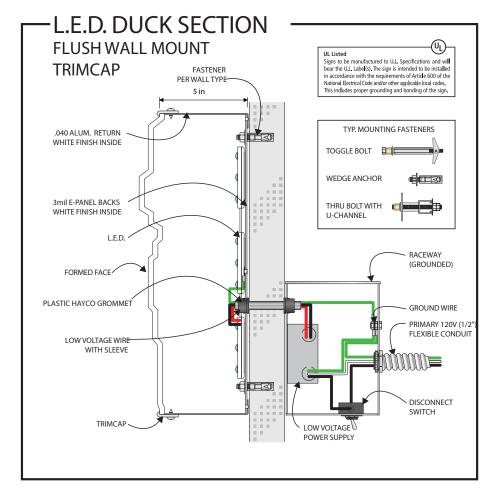

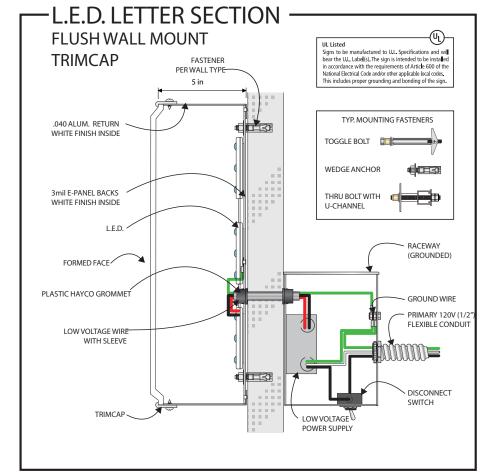



3750 East Outer Drive Detroit, MI 48234

t: 313.368.4000 f: 313.368.9335

www.fairmontsign.com



Quick Quack Car Wash #6-021 Dominguez Rd & Sierra College Blvd Rocklin, CA

Date:

12/13/17

File:

Accounts/Misc/Quick Quack/Elev/ Rocklin, CA_Sierra College

Designer:

Scale:

Jeane.

NA

Job# Sheet#

00000 5 of 8

Date:

Revision #

2 8-21-18 Revision Description:


nevision bescription

Customer Approval:

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UNLESS OTHERWISE NOTED, ALL COLORS PORTRAYED ARE REPRESENTATIVE ONLY.

NOTE: Renderings below utilize sample dimensions.

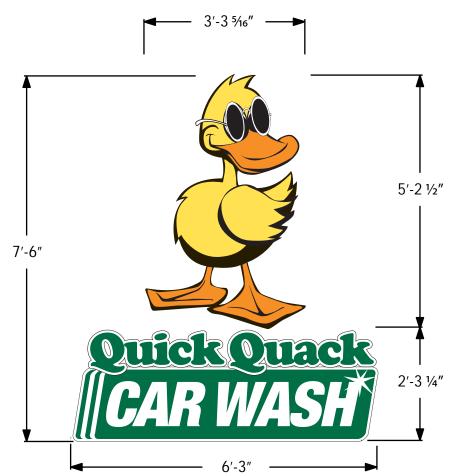

Vinyl Film Color Schedule A B C D 3M 3630-22 3M 3630-26 3M 3630-015 3M 3630-74 Black Green Yellow Kumquat Orange

Material Schedule


Fabricated aluminum, cloud-shaped channel construction. Face to be White acrylic with 3M vinyl film overlays (see color schedule). Returns and trimcap to be painted White. Cabinet to be internally illuminated with White LEDs.




(Stacked sign 46.9 SqFt Cloud sign 14.2 SqFt Duck 17.1 SqFt)

SIGN CABINET HAS A 3-D CONTOURED FACE



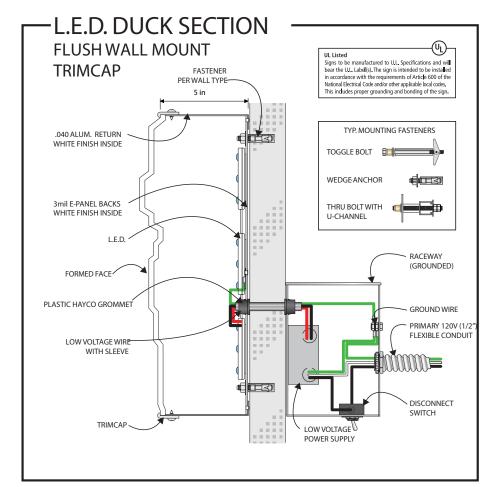

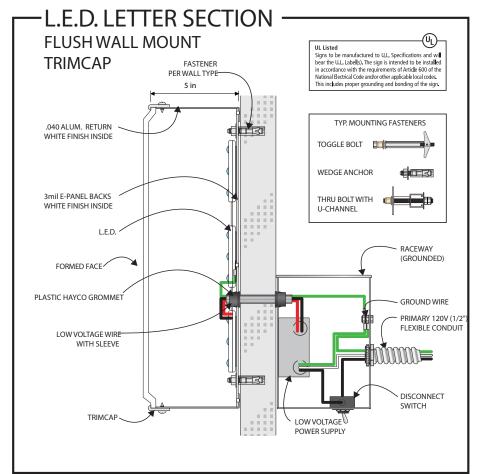



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Scale:

Jean

Job# Sheet# 00000 6 of 8

Revision # Date:

8-21-18

2

Revision Description:

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NOTE: Renderings below utilize sample dimensions.






QTY 1: LED Illuminated Wall Sign

Background is opaque- only copy lights.

(49.9 SqFt)

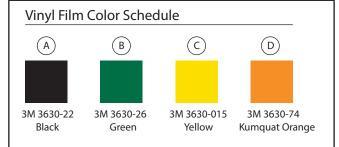



Material Schedule

Fabricated aluminum, cloud-shaped channel construction. Face to be White acrylic with 3M vinyl film overlays (see color schedule). Returns and trimcap to be painted White. Cabinet to be internally illuminated with White LEDs.



THREE DIMENSIONAL CONTOURED FACE W/ OPAQUE BACKGROUND PROVIDES AN INDIVIDUAL LETTER APPEARANCE

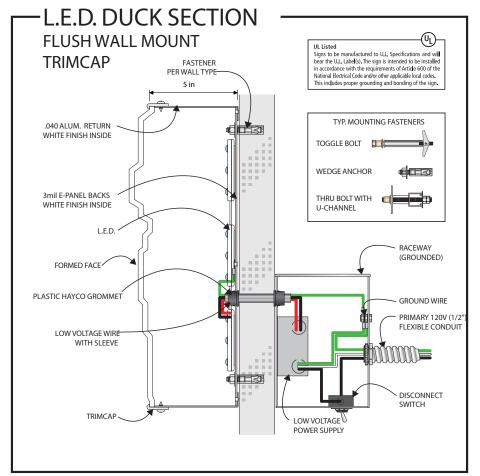

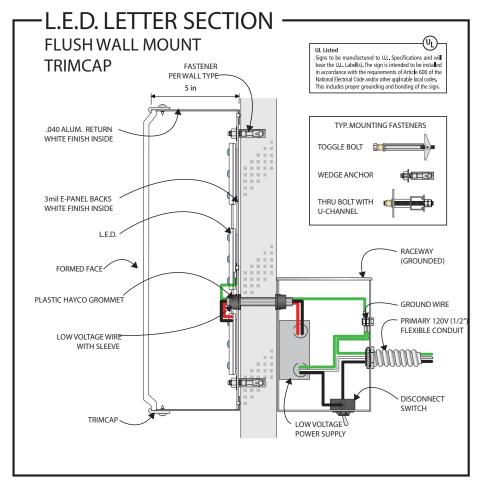



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Scale:

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00000 7 of 8

Revision # Date:

8-21-18

Revision Description:

Customer
Approval:

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NOTE: Renderings below utilize sample dimensions.




QTY 1: Reverse Pan Channel LED Halo Illuminated Numerals

Area for this sign not included in overall signage area calculation NOTE: Address must be confirmed.

Material Schedule

Numerals
Fabricated aluminum, reverse pan channel
construction with faces and returns painted Black,
satin finish. Backs to be Clear Lexan with 1-1/2"
stand-offs to peg off numerals from building fascia.
Numerals to be internally illuminated with White LEDs.

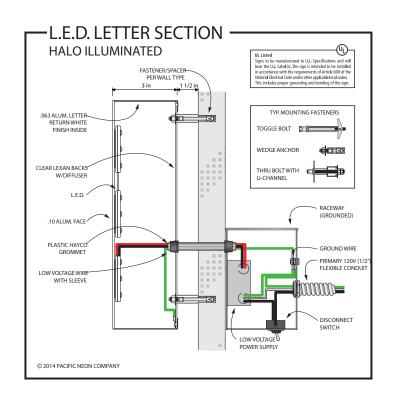



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