

## **New Project Information**

The City of Rocklin is processing the below referenced application(s) for project approval. The request is now being reviewed for compliance with the requirements and regulations of relevant City, State, and Federal agencies, and Utility providers. Once any issues have been resolved a hearing date will be set and public notice provided to alert neighbors and interested parties of the hearing date, availability of project information, the opportunity to comment on the project.

**Application Received:** September 22, 2023

#### **Project Name and Requested Approvals:**

#### Panda Express Whitney Ranch

- Design Review (DR2023-0013)
- Environmental (ENV2023-0012)

#### **Staff Description of Project:**

Request for approval of a Design Review (DR2023-0013) to allow for the development of two (2) freestanding restaurants with drive-thru features on an approximately 1.6-acre portion of an approximately 11.6-acre parcel. This parcel was split as part of a recently approved Tentative Parcel Map (DL2021-0003; Resolution No. PC-2022-60), but has not yet been recorded.

#### Location:

The project site is located west of the intersection of Whitney Ranch Parkway and Ocelot Way (formerly Cheetah Drive). The Assessor's Parcel Number (APN) is 017-171-039.

#### Land Use Designation(s)/Zoning:

The property is designated Mixed Use (MU). The property is zoned Planned Development Commercial (PD-C).

This project \_\_\_\_does / \_XX\_does not require modification or change of the land use designations and regulations currently applicable to the project site.

#### **Compliance with the California Environmental Quality Act:**

A preliminary review of this project pursuant to the California Environmental Quality Act (CEQA) has tentatively identified a Mitigated Negative Declaration as the appropriate level of environmental review for this project.

#### **Applicant & Property Owner:**

The property owner is Oakwood Trails 7V, LLC. The applicant is GWA Architecture, Inc.

#### **Attached Information:**

For additional detail, please visit the following link:

https://www.rocklin.ca.us/post/



## City of Rocklin

Planning Division 3970 Rocklin Road Rocklin, California 95677 Phone (916) 625-5160 FAX (916) 625-5195 UNIVERSAL APPLICATION FORM

NAME OF PROJECT: (P.	ANDA EXPRESS WHITNEY RAN	ICH)
LOCATION:		
Assessor's Parcel Numbers:		
DATE OF APPLICATION (STAFF): _9/22/23	RECEIVED BY (STAFF INITIALS): NR.	Α
FILE NUMBERS (STAFF): <u>DR2023-0013 &amp; ENV2023-0012</u>	FEE	s: \$21,117.00
<b>R</b> есеірт <b>N</b> о.: <u>R55795</u>		

#### **Pre-Application Meeting Requirements:**

It is required that a pre-application meeting be held with a Staff Planner prior to submitting most applications for planning entitlements and permits. The purpose of the pre-application meeting is to expedite application processing by enabling staff to work with the applicant to assure that the officially submitted application materials are in the proper format and that the applicant understands the City of Rocklin's goals, policies, and ordinances that may affect the project. A copy of these and other planning provisions is available at the applicant's request.

Generally, two sets of preliminary plans and a written description of the proposed project should be brought with the applicant to the pre-application meeting. To schedule this meeting, please contact a Staff Planner at the Rocklin Community Development Department by calling (916) 625-5160.

DATE OF PRE-APPLICATION MEETING: 03-13-2023

#### THIS APPLICATION IS FOR THE FOLLOWING ENTITLEMENTS: (CHECK APPROPRIATE SQUARES)

General Plan Amendment (GPA) Tentative Subdivision Map (SD) Use Permit (U) Minor (PC Approval – New Bldg) Fee: -Fee: Fee: Minor (PC Approval - Existing Bldg) Fee: BARRO Zone Application (BZ) Major (CC Approval) Fee: Rezone (Reclassification) (Z) Tentative Parcel Map (DL) Variance (V) Fee: -Fee: Fee: General Development Plan\*(PDG) Design Review (DR) Oak Tree Preservation Plan Permit Fee: \$13,792.00 Commercial **Planning Commission** Fee: Fee: City Council Residential Fee: Fee: Signs Fee: Concurrent Application (2 or more entitlements) **Modification to Approved Projects** Fee: Fee: File Number: **Environmental Requirements:** Mitigated Negative Declaration - \$7,325.00 Exempt -EIR - See Fee Schedule (STAFF) Negative Declaration -

#### **UNIVERSAL APPLICATION FORM (CONT.)**

GENERAL PLAN	PROPERTY DATA:	UTILITIES:	
DESIGNATION:		EXISTING	PROPOSED
Existing:	Acres:		
Proposed:	Square Feet:	Pub. Sewer	Pub. Sewer
		Septic Sewer	Septic Sewer
ZONING:	Dimensions:	Pub. Water	Pub. Water
Existing:	No. of Units:	Well Water	Well Water
		Electricity	Electricity
Proposed:	Building Size:	Gas	Gas
	Proposed	Cable	Cable
	Parking:		
	Required		
	Parking:		
	Access:		

#### **PROJECT REQUEST:**

Request for approval of design review to construct (2) free-standing restaurants with a drive-thru features within an existing 1.59 acre parcel.

(Example: Request for approval of design review to construct a 10,000 square foot office building on 1.5 acres)

NOTE: Annexations, Lot Line Adjustments, and Rocklin Ranch Industrial Park Specific Plan Use Permits require special application forms and additional submittal information available from the Planning Division.

### UNIVERSAL APPLICATION FORM (CONT.)

#### PLEASE PRINT OR TYPE:

NAME OF PROPERTY OWNER:		
ADDRESS:		·
CITY:	_STATE:	_ZIP:
PHONE NUMBER:		
EMAIL ADDRESS:		
FAX NUMBER:		
SIGNATURE OF OWNER	e letter if signature is o	ther than property owner.)
NAME OF APPLICANT (If different than owner):		
CONTACT:		
ADDRES		
CITY:	_STATE:	_ZIP:
PHONE NUMBER:		
EMAIL ADDRESS:		
FAX NUMBER:		
SIGNATURE OF APPLICANT		

#### **AGENT AUTHORIZATION FORM**

Property owners desiring to authorize individuals to represent them in conjunction with any application or matter before the City shall provide written authorization using this form. A separate form shall be used for each individual or firm authorized, and shall specifically note any restrictions upon the authorized person.

Project Name: CFT Development with Panda Express  Location: Intersection of Whitney Ranch Pkwy & Cheetah Dr.  Assessors Parcel Number(s): Portion of 017-171-039  Entitlements for which authorization is applicable (use permit, variance, tentative map, etc.):  Design Review, Conditional Use Permit, Environmental Review  Name of person and / or firm authorized to represent property owner (Please print):
GWA Architecture, Inc. c/o Ruben Rodela & Gary Wang
Address: 1000 Corporate Center Dr., Suite 550
City: Monterey Park State: CA Zip: 91754
Phone Number: 626-288-6898 Fax Number:
Email Address: ruben@garywang.com
The above named person or firm is authorized as:  Agent (X) Buyer () Lessee ()
The above named person or firm is authorized to (check all that are applicable):
(X) File any and all papers in conjunction with the aforementioned request, including signing the application
(X) Speak on behalf of and represent the owner at any Staff meeting and/or public hearing.
(X) Sign any and all papers in my stead, with the exception of the application form. The duration and validity of this authorization shall be:
(X) Unrestricted () Valid until:
Owners Authorization Signature & Date: Signature: Date: 9-22-23
Owners Name (Please Print): Peter M. Saetes, Manager
Owners Address: 1031 Roseville Parkway #148
City: Roseville State: CA Zip: 95678
Phone Number: 916 628-7778
Email Address: peter@saetesinvestments.com

#### **NOTIFICATION OF OWNERS OF MINERAL RIGHTS**

Government Code section 6509a(a)(2) states that if the Subdivision Map Act requires notice to be given pursuant to Section 65091, in addition to noticing the surrounding property owners, notice must also be given to anyone who has filed with the County recorder's office a "notice of intent to preserve the mineral right pursuant to Section 883.230 of the Civil Code" on the subject property.

Therefore, mailing labels must be provided with this application for any owner of a mineral right pertaining to the subject real property who has recorded a notice of intent to preserve the mineral right pursuant to Section 883.230 of the Civil Code (Subdivision Map Act Section 65091(a)(2)).

See page 24 of this application for instructions on how to submit mailing labels.

Section 65091(a)(2)

"(2) When the Subdivision Map Act (Div. d 9commencing with Section 66410)) requires notice of a public hearing to be given pursuant to this section, notice shall also be given to any owner of a mineral right pertaining to the subject property who has recorded a notice of intent to preserve the mineral right pursuant to Section 883.230 of the Civil Code."

Owner of Mineral Rights: Sunset Ranchos Investors, LLC 3255 West March Lane, Suite 400 Stockton, CA 95219

There are / are not (check one) owner	r(s) of record of preserved mineral rights on the
subject property and I,	, the applicant or applicant's representative,
have / have not (check one) provided the	e name and mailing address of record for any and all
owners of mineral rights pursuant to Section 883.230 of t	the Civil Code.
Ruben Rodela	
Signature	Date

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#### STATE OF CALIFORNIA **DEPARTMENT OF FISH AND GAME FILING FEES**

In 1990, the State adopted a fee pursuant to AB 3158 for the review of environmental documentation by the State Department of Fish and Game. Subsequently, in 1991, the fees were challenged. Then, in June 1995, the Department of Fish and Game instructed the jurisdictions to stop collecting fees. Following a great deal of court action and in a memorandum dated February 26, 1996, the State Clearinghouse, Office of Planning and Research, stated that the fees must again be collected.

On September 29, 2006, Senate Bill 1535 was passed increasing the amounts of filing fees collected by the Department, and requires the Department to adjust the fees annually pursuant to Fish and Game Code Section 713.

As of January 1, 2020, State law requires all applicants who have a Notice of Determination filed for a Negative Declaration to pay a \$2,406.75 fee and those with a Notice of Determination for an Environmental Impact Report to pay a \$3,343.25 fee. Both types must pay an additional \$50.00 administrative fee making the total fees \$2,456.75 and \$3,393.25 respectively. Applicants whose projects require the filing of a Notice of Exemption will need to pay a \$50.00 administrative fee. The City will notify each applicant which of the fees must be paid.

PLEASE NOTE: Effective January 1, 2008, the fee exemption for projects determined to have a De Minimis *Impact Finding* has been eliminated. (Section 711.4 Fish and Game Code).

The Fish and Game filing fee must be paid prior to the filing of the Notice of Determination with the County Clerk. Since the CEQA law requires a Notice of Determination to be filed with the County within 5 days of an action by the City, all applicants must remit to the City the necessary fee amount no later than the day of the final scheduled public hearing for the proposed project.

#### PLEASE MAKE ALL CHECKS PAYABLE TO PLACER COUNTY.

If you have any questions regarding this matter, please do not hesitate to contact the Planning Department at (916) 625-5160. Upon review of the above, please sign and return this document with your application.

I, Ruben Rodela above and understand its meaning.	, the applicant or applicant's representative, have read the information
Ruben Rodela	9/1/23
Signature	Date

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#### **HAZARDOUS WASTE AND SUBSTANCES STATEMENT**

	Sites List (Cortese List), consolidat	ection 56962.5, I have consulted the Hazardous Waste and ed by the State of California, Environmental Protection Agency
	the Hazardous Waste and Substa	is, $\underline{X}$ is not (check which applies) located on a site which is notes Sites List (Cortese List). If on the list, provide the following
Regulatory	identification number:	Date of list:
Type of pro	blem:	
I declare un	der penalty of perjury of the laws o	of the State of California that the foregoing is true and correct.
Dated:	9/1/23	
Applicant:_	Ruben Rodela	
List), availal	ble for review at the City of Rocklin	wing the Hazardous Waste and Substances Sites List (Cortese Planning Department counter, or at the California Department <a href="www.calepa.ca.gov/SiteCleanup/CorteseList/default.htm">www.calepa.ca.gov/SiteCleanup/CorteseList/default.htm</a>

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#### **MITIGATION FOR AIR QUALITY IMPACTS**

The US Environmental Protection Agency (EPA) and the California Air Resources Board (CARB) have established air quality standards, referred to as the National Ambient Air Quality Standards (NAAQS) and the State Ambient Air Quality Standards (SAAQS) respectively. The federal Clean Air Act and State Clean Air Act both require that areas in violation of the ambient air quality standards adopt strategies to attain these standards. The Placer County Air Pollution Control District (APCD) has primary responsibility for planning and maintenance and/or attainment of air quality standards within Placer County. California is divided into 15 air basins for the purpose of monitoring air quality. Placer County is included in the Sacramento Valley Air Basin. Areas may be classified as attainment, non-attainment, or unclassified with regard to the adopted standards. The unclassified designation is assigned in cases where monitoring data is insufficient to make a definitive determination. Under the federal standards, all of Placer County, including Rocklin, is designated as nonattainment for ozone. All other pollutants are designated unclassified in Rocklin. Under the state standards, South Placer, including Rocklin, is designated as non attainment for ozone and PM10 and unclassified for hydrogen sulfide and visibility reducing particulate.

The project would have the following short-term construction impacts, if not mitigated:

- a. Construction activities, including grading, would generate a variety of pollutants, the most significant of which would be dust (PM10). This would exacerbate the existing PM10 non attainment condition if not mitigated.
- b. Construction equipment would produce short-term combustion emissions, and asphalt materials used for streets and driveways would produce pollutants during curing.

The mitigation measures listed below will reduce the short term impacts to less-than-significant. In the longterm, vehicle trips to and from the project site would generate Carbon Monoxide and ozone precursor emissions, thereby contributing to the non-attainment status of the local air basin. These incremental and cumulative adverse air quality impacts cannot be completely mitigated. However, these impacts were anticipated by the City of Rocklin General Plan, and were addressed through the 1991 Rocklin General Plan EIR and the North Rocklin Circulation and Traffic Study. Findings of overriding significance were adopted for the unmitigatable and unavoidable significant air quality impacts.

Therefore, I, as the applicant for the proposed project, agree that the mitigation measures listed below are incorporated as a part of my project description in order to mitigate for the short term impacts.

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#### MITIGATION FOR AIR QUALITY IMPACTS (CONT.)

#### **MITIGATIONS**

- 1. The project shall conform with the requirements of the Placer County APCD.
- 2. Prior to commencement of grading, the applicant shall submit a dust control plan for approval by the City Engineer and the Placer County Air Pollution Control District. The plans shall specify measures to reduce dust pollution during all phases of construction.
- 3. Traffic speeds on all unpaved road surfaces shall be posted at 25 m.p.h. or less.
- 4. All grading operations shall be suspended when wind speeds exceed 25 m.p.h.
- 5. All trucks leaving the site shall be washed off to eliminate dust and debris.
- 6. All construction equipment shall be maintained in clean condition.
- 7. All exposed surfaces shall be revegetated as quickly as feasible.
- 8. If fill dirt is brought to the construction site, tarps or soil stabilizers shall be placed on the dirt piles to minimize dust problems.
- 9. Apply water or dust palliatives on all exposed earth surfaces as necessary to control dust. Construction contracts shall include dust control treatment as frequently as necessary to minimize dust.
- 10. Construction equipment shall be properly maintained and tuned.
- 11. Utilize low emission mobile construction equipment where possible.
- 12. Open burning of vegetative material is prohibited.

Dubas Dadala

Applicant's Name (printed)	
Ruben Rodela	9/1/23
Applicant's Signature	Date



# City of Rocklin

Planning Division 3970 Rocklin Road Rocklin, California 95677 Phone (916) 625-5160 FAX (916) 625-5195

# ENVIRONMENTAL INFORMATION SHEET

(To be completed by applicant)

LOCATION OF PROJE	CT (ADDRESS)	ersection of Whitney Ranch Pl	kwy & Cheetah Drive
Сіту:		STATE:	ZIP:
Assessors Parcel	#:		
NAME OF PROJECT:			
CONTACT/APPLICAN	NT <b>N</b> AME:		
Address:			
CITY:		STATE:	<u>ZIP:</u>
PHONE:		EMAIL:	
		ail. Add separate sheet if nece	
Property size:	Square Feet	Acres	
Land Use:	Existing	Proposed	
		art or portion of a larger proje r other project identification:	ct, describe the previous project by name,
	ntal impact report ha		r project for which a negative declaration , reference the document below. Include
OTHER REQUIRED PI Permit or Approv	ERMITS OR APPROVALS: al Agency	<u>Address</u>	Contact Person/Phone

**PREVIOUS LAND USES:** Describe existing and previous land uses of the site for the last 10 years or more:

#### SITE CHARACTERISTICS

1.

2.	Wha	t are the surrou	inding land uses?					
	East_		West		North		South	
3.	Is the	e project propos	sed on land which c	ontains fill o	or a slope of 10	0% or mo	ore?	
4.	Are t	there any existir	ng erosion problems	s?				
5.	lique	efaction, slope in	sive soils (as defined nstability or other re ail, or refer to attac	elated hazar	ds?			
6.	Grad	ling, excavating	or filling activities -	Quantity of	cubic yards to	be:		
	a.	Moved within	the site:					 _
	b.	Deposited on	the site:					<u> </u>
	c.	Removed from	m the site:					_
	d.	Disposal site:						_
7.		there any strear cribe:	ns or permanent wa	ater courses	on the site?			
8.		the proposed pi explain. If not, v	roject change draina why not:		s or the quality	_	ndwater?	
9.		the project affe	ct any drainage cha	nnel, creek,	pond or any o	other wa	er body?	
10.		y portion of the describe:	property located ir	n a flood pla	in?			

What natural features (trees, rock outcroppings etc.) presently exist on the site?

11.	Are there any jurisdictional wetlands or vernal pools on the site?
12.	Are there any trees or shrubs on the project site?
	What types?
	Are any to be removed or transplanted?
	State the location of transplant site:  State the number & species to be removed:
	State the number & species to be removed.
13.	Will the project affect the habitat of any endangered, threatened, or other special status species?
14.	Will the project result in any new noise source, or will it place new residents in an area of high traffic noise or noise from any other source?
15.	What type of equipment will be associated with the project during construction?
	During permanent operation?
16.	Describe any air pollutants, other than vehicle exhaust, which would be generated by this project, both during and after construction. Dust particulates are considered pollutants.
17.	Will the project produce new sources of dust, ash, smoke, fumes or objectionable odor?
18.	Will the project create any new light source, other than street lighting?
19.	Is this property covered by a Williamson Act contract?
20.	Has this property ever been used for agricultural purposes?
21.	Does the project involve the use of routine transport or disposal of hazardous materials?
22.	Are there any known mineral resources of value to the region and the residents of the state located on the site? If so, what types?
23.	How close is the nearest school?

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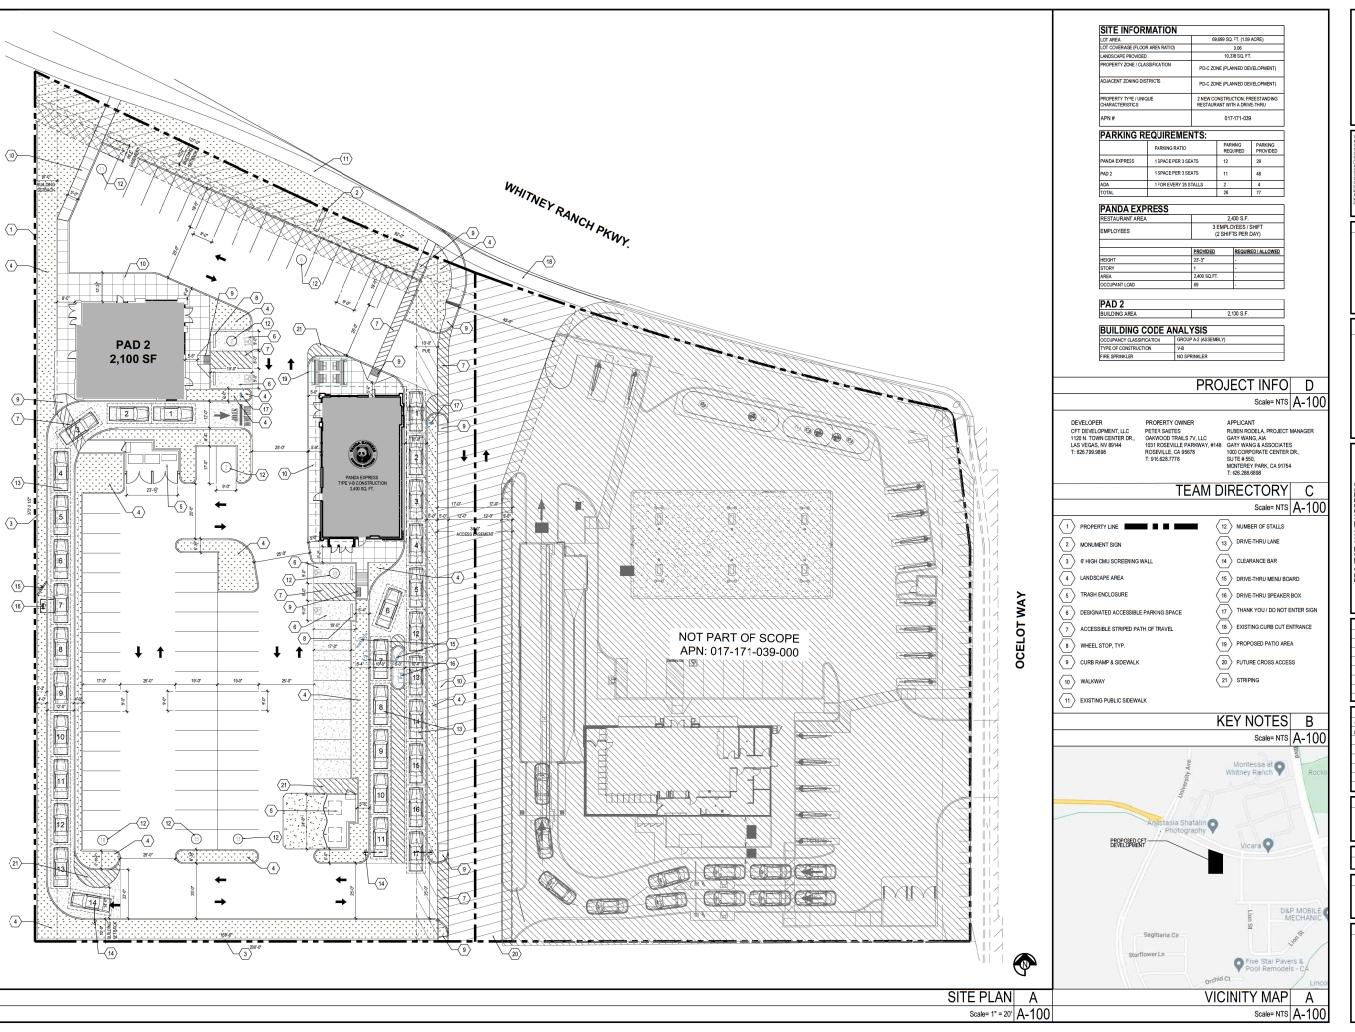
Number of floors/stories	s:			
Height of other appurter	nances (antennas,	steeples, mechanica	al equipment, etc.) me	asured from ground
Project site coverage:	Building		sq.ft	%
	Landscaping		sq.ft	%
	Paving		sq.ft	%
Exterior building materia	als:			
Exterior building colors:				
Wall and/or fencing mat	erial:			
Total number of off-stre				
Total number of bicycle				
RESIDENTIAL PROJECTS  Total lots		Total dwelling uni	its	
Density/acre		Total acreage		
	Single Family	Two Family	Multi-Family (More than 2 units)	
Number of Units				
Size of lot/unit				
Studio				
1 Bedroom 2 Bedroom				
1 Bedroom 2 Bedroom 3 Bedroom				
1 Bedroom 2 Bedroom				
1 Bedroom 2 Bedroom 3 Bedroom	•			
1 Bedroom 2 Bedroom 3 Bedroom 4+ Bedroom  RETAIL, COMMERCIAL, IND  Type of use(s):	•			
1 Bedroom 2 Bedroom 3 Bedroom 4+ Bedroom  RETAIL, COMMERCIAL, IND  Type of use(s):  Oriented to: Regional		City	_ Neighborhood	
1 Bedroom 2 Bedroom 3 Bedroom 4+ Bedroom  RETAIL, COMMERCIAL, IND  Type of use(s):		City	_ Neighborhood	
1 Bedroom 2 Bedroom 3 Bedroom 4+ Bedroom  RETAIL, COMMERCIAL, IND  Type of use(s):  Oriented to: Regional Hours of operation:	g capacity:	City	_ Neighborhood	

PROPOSED BUILDING CHARACTERISTICS (BOTH RESIDENTIAL AND NON-RESIDENTIAL)

24.

#### **ALL PROJECTS**

28.	Approximately how many tons of solid waste will the project produce each year?
29.	Will the proposed use involve any toxic or hazardous material?
	Is the project site within 2,000 feet of an identified hazardous/toxic site?
	Is the project site within 2,000 feet of a school or hospital?
	If the project involves any hazardous material, explain:
30.	How many new residents is the project estimated to generate?
31.	Will the project generate a demand for additional housing?
32.	What is the current and estimated number of motor vehicles to arrive at the site as a result of the project?
	Current: Estimated:
33.	Could the project increase traffic hazards to motor vehicles, bicyclists or pedestrians?
34.	How close is the project to the nearest public park or recreation area?
35.	What school districts will be affected by this project?
36.	Describe energy-efficient features included in the project
37.	Describe how the following services or utilities will be provided:
	Power and Natural Gas:
	Telephone:
	Water:
	Sewer:
	Storm Drainage:
	Solid Waste:
38.	Will the project block any vista or view currently enjoyed by the public?
39.	Are there any known historic or significant building features on or near the site?
40.	Are there any archaeological features on the site?  If so, will the project result in any impact to these features?





Developments, LLC

CHERNG FAMILY TRUST, INC.
1120 N, Town Center Dr.
Los Vegos, Nevodo
89144
Telephone: 526.799.9598
Focsimile: 526.372.8288







	ISSUE DATE:	
1ST	PRE APPLICATION SUBMITTAL	01-20-2023
2ND	1ST DRB & CUP SUBMITTAL	09-01-2023

REVISIONS:


JOB NUMBER 23-011

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SHEET CONTENT

SITE PLAN
ARCHITECTURAL

SHEET NO



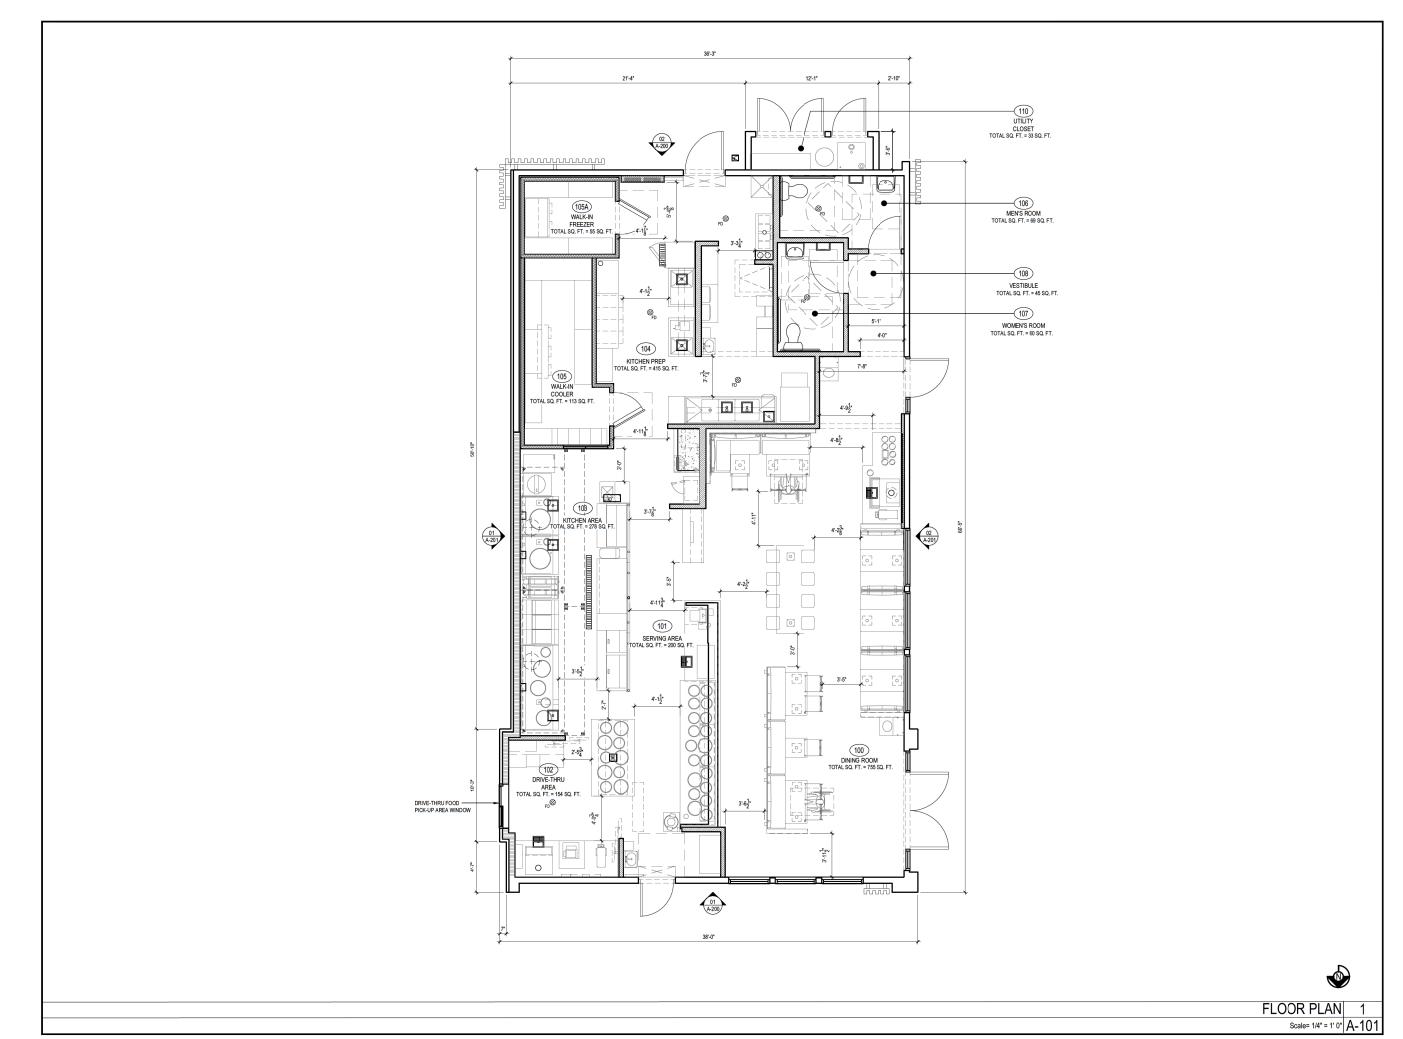

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Monterey Park, CA 91754

TEL: (626) 288-6698 FAX: (626) 768-1119://www.garywang.com







CFT DEVELOPMENTS DE0116 S8-26-I

REVISIONS:			

1ST	PRE APPLICATION SUBMITTAL	01-20-2023
2ND	1ST DRB & CUP SUBMITTAL	09-01-2023

JOB NUMBER 23-011

DRAWN BY RR/CL/NL

SHEET CONTENT
FLOOR PLAN

SHEET NO

### ROOF PLAN KEYNOTES:

CONDENSER UNITS
CAPTIVEAIRE MODEL: # 24ABB360 MA-1 CAPTIVEAIRE MODEL: EA3-D.500-24D-MPU R3 RTU-1 LENNOX MODEL:KGB074H4T HEIGHT:46-7/8" RTU-2 LENNOX MODEL: KGA120H4M HEIGHT:46-7/8" R5 RTU-3 LENNOX MODEL:KGA120H4M HEIGHT:46-7/8"

R6 EF-1 CAPTIVEAIRE MODEL:DU200HFA HEIGHT:63-3/8"

EF-2 CAPTIVEAIRE MODEL:DU200HFA HEIGHT:63-3/8"

R8 EF-3 CAPTIVEAIRE MODEL:DR12HFA HEIGHT:28-1/4" R9 CONDENSER UNITS AND RACK MODEL:

R10 CONDENSER UNIT AND RACK MODEL:
TAPERED ROOF INSULATION CRICKET TO ASSURE POSITIVE ROOF DRAINAGE HEIGHT:48"

R12 WATER HEATER VENT - SEE MEP PLANS. OFFSET VENTS AS REQUIRED TO MAINTAIN MIN. 10'-0" AWAY FROM AIR INTAKE SYSTEMS ON EQUIPMENT

R13 ROOF ACCESS HATCH LOCATE BETWEEN 2
ADJACENT TRUSSES
R14 PLUMBING VENT

R15 WEATHER PROOF HYDRANT


R16 PROVIDE WALK-WAY PAD AS SHOWN

POWER SUPPLY LOCATION FOR ROOFTOP EXHAUST FANS FOR KITCHEN HOOD

R18 SCUPPER LOCATION

R19 TOP OF PARAPET

R20 ROOF DECK

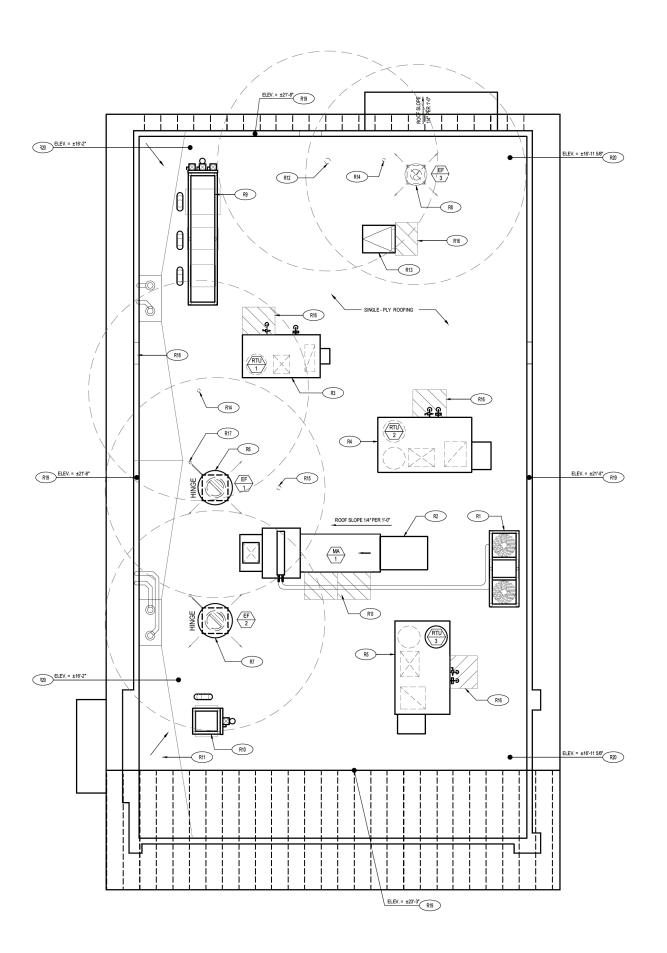







1000 Corporate Center Dr., Suite 550 Monterey Park, CA 91754 TEL: (626) 288-6898 FAX: (626) 768-7101 http://www.garywang.com





DEVELOPMENT DE0116

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REVISIONS:

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ST	PRE APPLICATION SUBMITTAL	01-20-2
ND	1ST DRB & CUP SUBMITTAL	09-01-2

JOB NUMBER 23-011

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ROOF PLAN


SHEET NO

A-107




ROOF PLAN 1 Scale= 1/4" = 1'-0" A-107



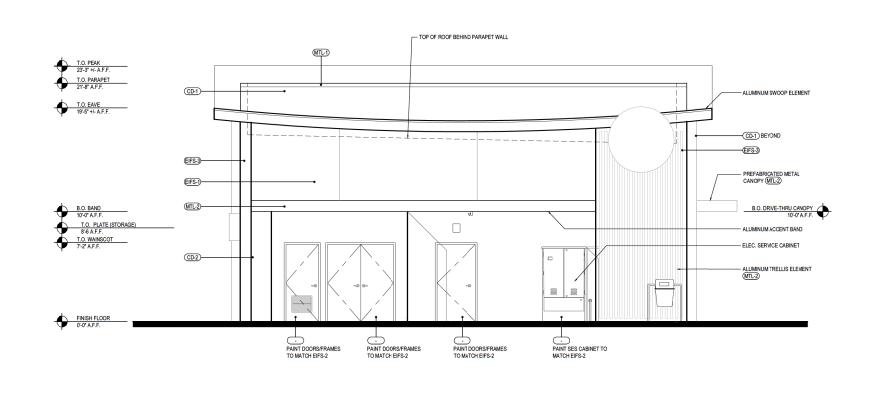

SOUTH ELEVATION 2

Scale= 1/4" = 1'-0" A-200

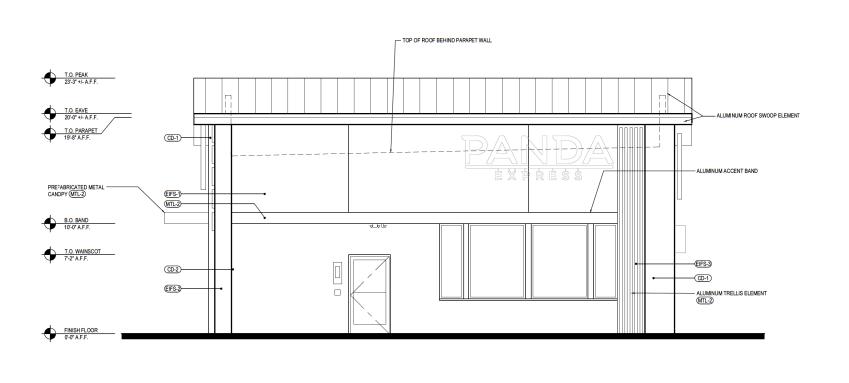


NORTH ELEVATION

Scale= 1/4" = 1'-0" A-200



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2ND	1ST DRB & CUP SUBMITTAL	09-01-2023

REVISIONS:
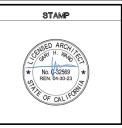
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1ST	PRE APPLICATION SUBMITTAL	01-20-2023
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JOB NUMBER 23-011

DRAWN BY

SHEET CONTENT

EXTERIOR ELEVATIONS

SHEET NO

EIFS (EIFS-I)
MANUFACTURE: STO
PRODUCT: STOTHERM
ESSENCE SYSTEM
COLOR: SW 7646
FIRST STAR
FINISH: FINE

EIFS (EIFS-2)

MANUFACTURE: STO

PRODUCT: STOTHERM

ESSENCE SYSTEM

COLOR: SW 7069

IRON ORE

FINISH: FINE

EIFS (EIFS-3)

MANUFACTURE: STO

PRODUCT: STOTHERM

ESSENCE SYSTEM

COLOR: PANTONE

COLOR 200C — RED

FINISH: FINE


CD-1 (CD-1)
MANUFACTURE: FIBERON
PRODUCT: WILDWOOD
COLOR: BAMBOO

CD-2 (20-2)

MANUFACTURE:
SHERWIN WILLIAMS
PRODUCT:
CEMENT FIBER SIDING
COLOR: STONY CREEK

METAL CAP (MTL-1)
MANUFACTURE:
EXCEPTIONAL METALS
PRODUCT: —
COLOR: IRON ORE
FINISH: SMOOTH

CANOPY (MT.2)
MANUFACTURE: PANDA
VENDOR
PRODUCT: ALLEN
INDUSTRIES
COLOR: PMS BLACK-7C
FINISH: SATIN

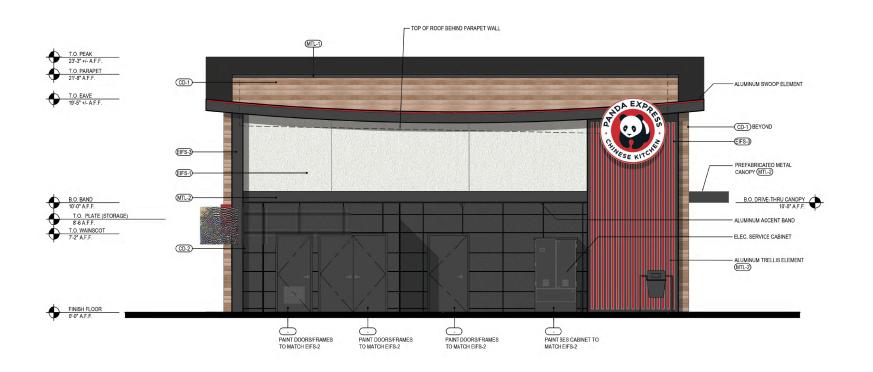

SOUTH ELEVATION 2

Scale= 1/4" = 1'-0" A-200



NORTH ELEVATION

Scale= 1/4" = 1'-0" A-200




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CONSULTANT

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GARY WANG
& ASSOCIATES, INC.

1000 Corporate Center Dr., Suite 550 Monterey Park, CA 91754 TEL: (626) 288-6898 FAX: (626) 768-7101 http://www.garywang.com

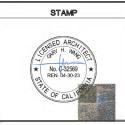

REVISIONS:

ISSUE DATE:
1ST PRE APPLICATION SUBMITTAL 01-20-2023
2ND 1ST DR8 & CUP SUBMITTAL 09-01-2023

JOB NUMBER 23-011


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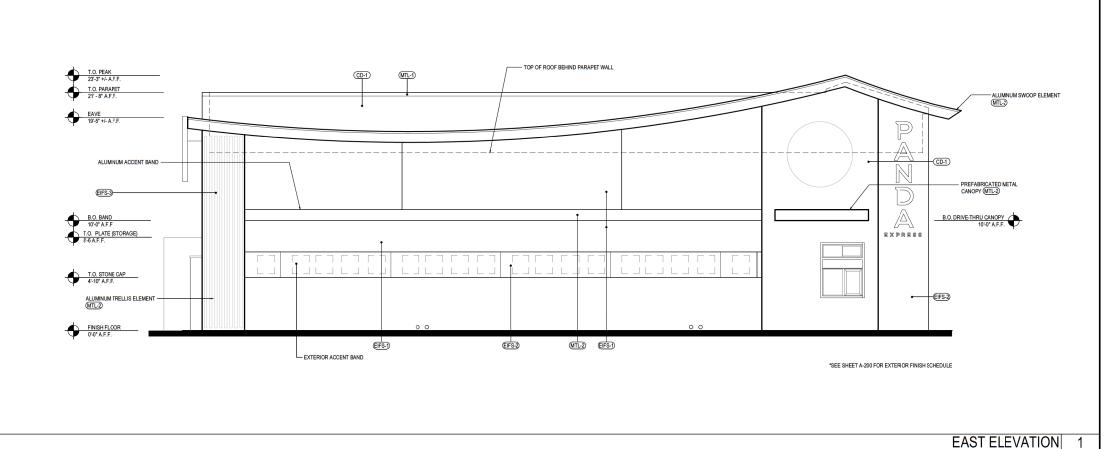
SHEET CONTENT

EXTERIOR ELEVATIONS

SHEET NO





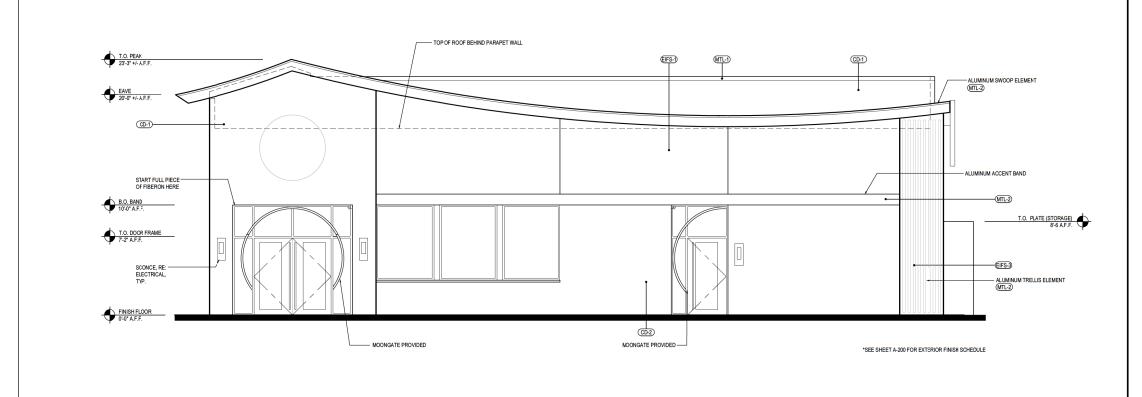



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WEST ELEVATION 2

Scale= 1/4" = 1'-0" A-201

Scale= 1/4" = 1'-0" A-201

REVISIONS:		
ISSUE DATE:		

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2ND	1ST DRB & CUP SUBMITTAL	09-01-2023				

JOB NUMBER 23-011

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SHEET CONTENT

EXTERIOR ELEVATIONS

SHEET NO

EIFS (EIF8-1) MANUFACTURE: STO PRODUCT: STOTHERM ESSENCE SYSTEM COLOR: SW 7646 FIRST STAR FINISH: FINE

EIFS (EIFS-2) MANUFACTURE: STO PRODUCT: STOTHERM ESSENCE SYSTEM COLOR: SW 7069 IRON ORE FINISH: FINE


> EIFS (EIF8-3) MANUFACTURE: STO PRODUCT: STOTHERM ESSENCE SYSTEM COLOR: PANTONE COLOR 200C — RED FINISH: FINE

CD-1 **CD-1** MANUFACTURE: FIBERON PRODUCT: WILDWOOD COLOR: BAMBOO

CD-2 CD-2 MANUFACTURE: SHERWIN WILLIAMS PRODUCT: CEMENT FIBER SIDING COLOR: STONY CREEK


METAL CAP MTL-1 MANUFACTURE: EXCEPTIONAL METALS PRODUCT: -COLOR: IRON ORE FINISH: SMOOTH

CANOPY (MTL-2)
MANUFACTURE: PANDA VENDOR PRODUCT: ALLEN **INDUSTRIES** COLOR: PMS BLACK-7C FINISH: SATIN

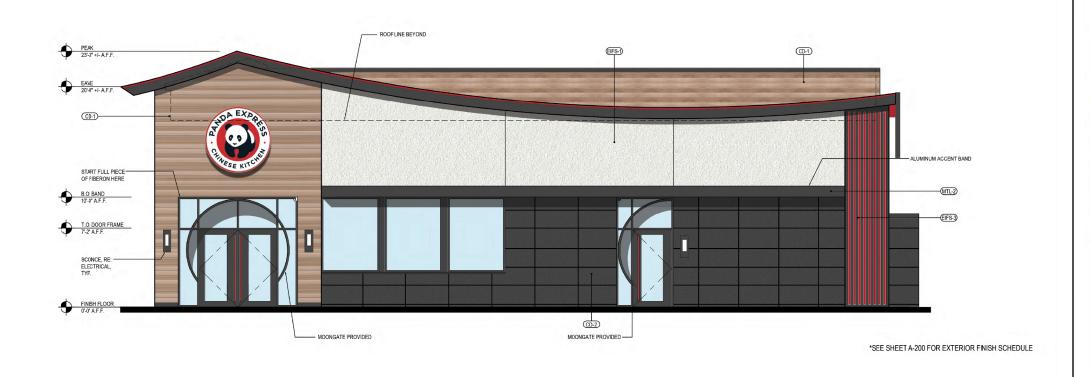

EAST ELEVATION 2

Scale= 1/4" = 1'-0" A-201

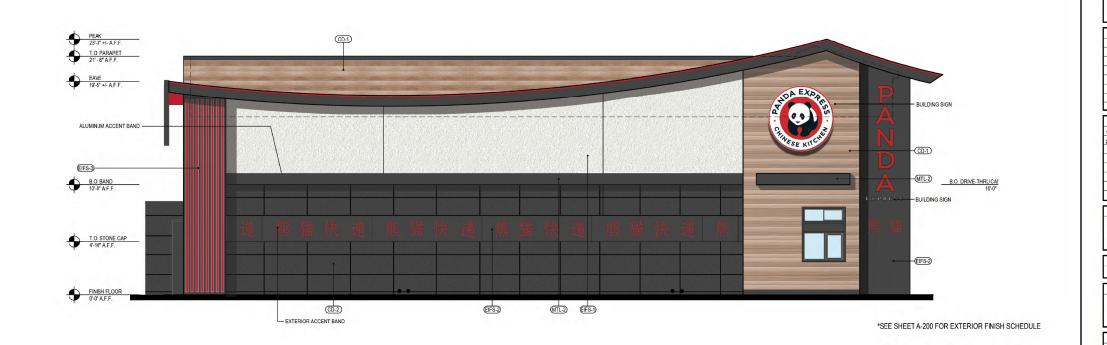

WEST ELEVATION

Scale= 1/4" = 1'-0" A-201



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S8-26-D23303 NEY RANCH PKWY & CHEETAH ROCKLIN, CA 95765  $C_{\text{DEVELOPM}}$ 

REVISIONS:

ISSUE DATE:				
1ST	PRE APPLICATION SUBMITTAL	01-20-2023		
2ND	1ST DRB & CUP SUBMITTAL	09-01-2023		
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JOB NUMBER 23-011

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SHEET CONTENT

EXTERIOR ELEVATIONS

SHEET NO





VIEW 2

Scale= NTS A-203 VIEW 4 Scale= NTS A-203









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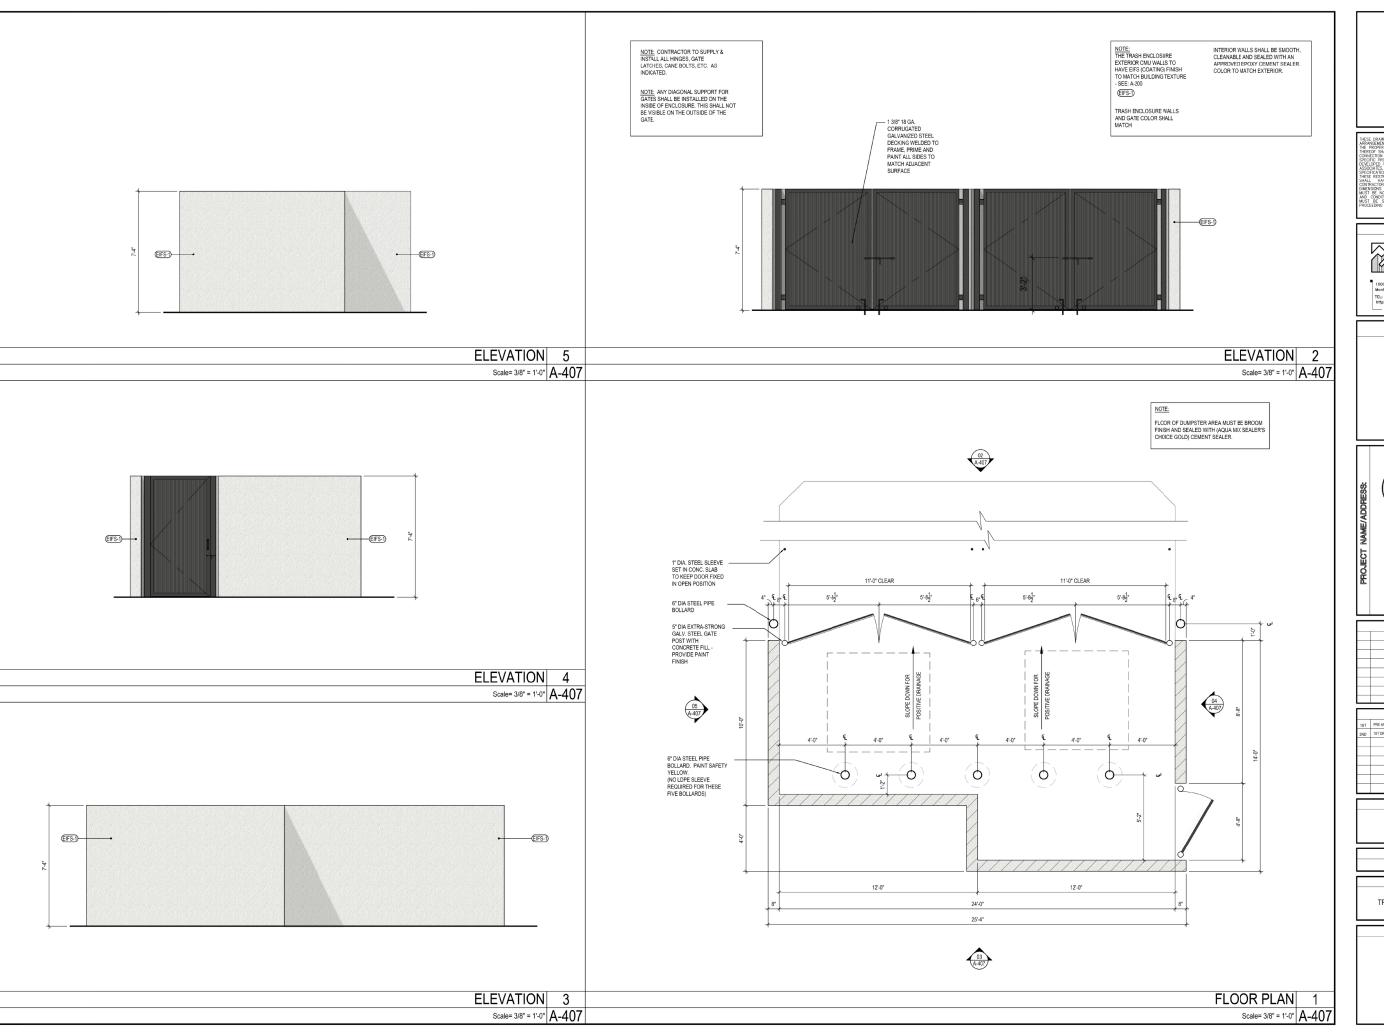
SHEET CONTENT EXTERIOR RENDERS

SHEET NO

A-203

VIEW 3 Scale= NTS A-203

VIEW 1 Scale= NTS A-203





Developments, LLC
CHERNG FAMILY TRUST, INC.
1120 N. Town Center Dr.
Los Veget
Heroda
Telephone: 626.799.9998
Facsimile: 626.372.8288

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CONSULTANT



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REVISIONS:

	ISSUE	DATE:
1ST	PRE APPLICATION SUBMITTAL	01-20-202
2ND	1ST DRB & CUP SUBMITTAL	09-01-202

JOB NUMBER 23-011

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SHEET CONTENT

TRASH ENCLOSURE DETAILS

SHEET NO

# PRELIMINARY LANDSCAPE PLAN

PLANTING LEGEND:

**TREES** 

SYMBOL BOTANICAL NAME/COMMON NAME/SIZE



CERCIS OCCIDENTALIS 24" BOX WESTERN REDBUD MULTI TRUNK



PISTACIA CHINENSIS 24" BOX CHINESE PISTACHE



MAGNOLIA GRANDIFLORA 24" BOX MAGNOLIA 'LITTLE GEM'



RHUS LANCEA 24" BOX AFRICAN SUMAC

#### SHRUBS

 $\oplus$ 

SYMBOL BOTANICAL NAME/COMMON NAME/SIZE

- HEMEROCALLIS SPECIES 'DOUBLE YELLOW' DAYLILY 5 GALLON
- PHORMIUM TENAX NEW ZEALAND FLAX "SUNSET" 5 GALLON
- XYLOSMA COMPACTA COMPACT SHINY XYLOSMA 5 GALLON
- RAPHIOLEPSIS INDICA 'BALLERINA' INDIAN HAWTHORNE 5 GALLON
- LIGUSTRUM JAPONICUM 'TEXANUM' • PRIVET HEDGE 5 GALLON

#### SHRUBS

SYMBOL BOTANICAL NAME/COMMON NAME/SIZE


- NANDINA DOMESTICA DWARF 'FIRE POWER' HEAVENLY BAMBOO 5 GALLON
- LIRIOPE MUSCARI 'SILVERY SUNPROOF' BIG BLUE LILY
- RAPHIOLEPSIS INDICA 'PINK DANCER' INDIAN HAWTHORNE 5 GALLON

#### **VINES**

SYMBOL BOTANICAL NAME/COMMON NAME/SIZE

PARTHENOCISSUS TRICUSPIDATA BOSTON IVY VINE TRAIN TO TRASH ENCLOSURE

GENERAL GROUNDCOVER NOTE: PROVIDE 3" LAYER OF RIVER ROCK MULCH AS TOP DRESSING FOR ALL NEW PLANTER AREAS PROVIDE WEED FABRIC UNDER RIVER ROCK MULCH

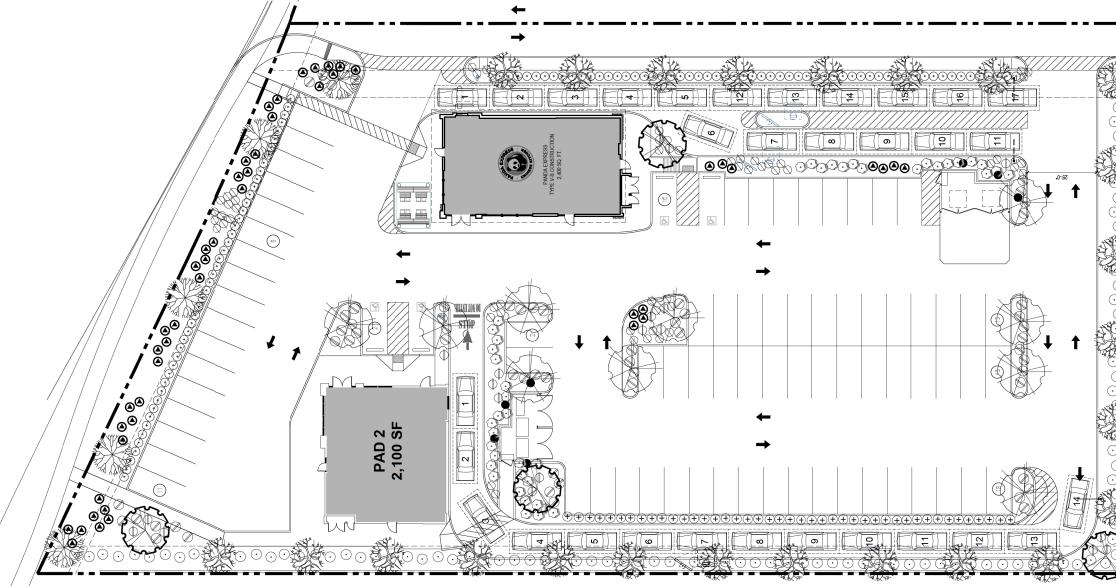

LANDSCAPE PLAN PREPARED BY **GENE HIRAO** 15 POSADA IRVINE, CALIFORNIA 92614 TEL (714) 296-9811 GHJH@COX.NET

SCALE: 1/16" = 1' - 0"

PRELIMINARY LANDSCAPE PLAN



TEL: (626) 288-6898 FAX: (626) 768-710 http://www.gorywang.com

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DEVELOPA DE0116 REVISIONS:

ISSUE DATE:

JOB NUMBER 23-011

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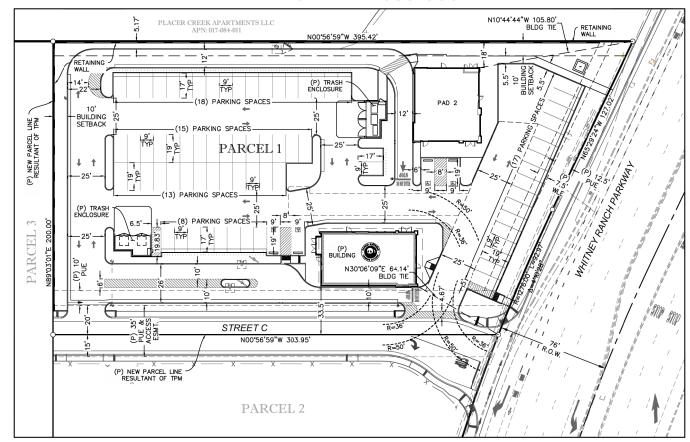
SHEET CONTENT PRELIMINARY LANDSCAPE PLAN

SHEET NO

L-100

# PANDA EXPRESS ROCKLIN PRELIMINARY IMPROVEMENT PLANS WHITNEY RANCH PARKWAY

ROCKLIN, CA APN: 017-171-039-000



#### \_13.34 AC 13.61 AC MATCH (E) MATCH (E) GRADE ELEVATION TRUNCATED DOMES 00000 BUILDING

FIRE HYDRANT

FF: 123.00

GB

△ 100.00 PK

FF: 123.00

REMOVAL

#### **ABBREVIATIONS:** AGGREGATE BASE

GRADE BREAK LINE

TREE & DRIP

CONTROL POINT

FINISH FLOOR ELEVATION

IC .	ASPHALT CONCRETE
\RV	AIR RELEASE VALVE
BC .	BEGIN CURVE
CR	BEGIN CURVE RETURN
LDG	BUILDING
OC.	BACK OF CURB
80W	BACK-OF-WALK
3VC	BEGIN VERTICAL CURVE
W.	BOTTOM OF WALL
AB	CABINET
ONC	CONCRETE
2&G	CURB & GUTTER
G&S	CURB, GUTTER & SIDEWALK

FIRE HYDRANT
FLOWLINE
FACE OF CURB
FINISH PAVEMENT
FIRE SPRINKLER
GRADE BREAK
GRATE ELEVATION
GATE VALVE
GROSS VEHICLE WEIGHT
HANDICAP
HANDICAP
HIGH DENSITY POI YETH HIGH POINT IRRIGATION INVERT CHORD
CENTERLINE
CORRUGATED METAL PIPE
CURB RETURN
CABLE TV
A DOUBLE CHECK DETECTOR
ASSEMBLY
DRAIN, OPPOD IN ET DRAIN / DROP INLE MAXIMUM DOWN SPOUT MINIMUM END CURVE NORTHEAST END CURB RETURN
EDGE OF PAVEMENT
EDGE OF TRAVELED WAY

HDPE HIGH DENSITY POLYETHYLENE INVERT
INVERT ELEVATION
JOINT POLE
LENGTH
LINEAL FEET
LIP OF GUTTER
LOW POINT
LEFT TURN OR LEFT MAINTENANCE HOLE NORTHWEST ON CENTER ETW EDGE OF TRAVELED WAY
EVC END OF VERTICAL CURVE
FDC FIRE DEPARTMENT CONNECTION
FF FINISH FLOOR
FG FINISHED GROUND
FGBW FINISHED GROUND @ BOT WALL
FGTW FINISHED GROUND @ TOP OF WALL (P) PCC PG

₹E OVERHEAD TELEPHONE & ELECTR OPEN METAL PIPE PROPOSED PORTLAND CEMENT CONCRETE OR POINT OF COMPOUND CURVE PROFILE GRADE

SASD SACRAMENTO AREA SEWER DIS
SOMH STORM DRAIN MANHOLE
SD STORM DRAIN MANHOLE
SD SOUTHEAST
SS SANITARY SEWER
SSCO SANITARY SEWER CLEAN OUT
SSMH SANITARY SEWER MANHOLE
SWCT SAWCUT
SW SIDEWALK OR SOUTHWEST
STA
STATION
TO TOP OF CURB
TP TOP OF FAVEMENT
TS TOP OF SIDEWALK TOP OF SIDEWALK TOP OF WALL TOP OF WALL
UNLESS NOTED OTHERWISE
WATER
WATER VALVE
WATER METER
WELDED WITE FABRIC
WELDED WITE FABRIC VITRIFIED CLAY PIPE VERIFY-IN-FIELD

PIV POST INDICATOR VALVE
R PROPERTY LINE
POC POINT OF CONNECTION
PRC POINT OF REVERSE CURVE
POINT OF TANGENCY
PUE PUBLIC UTILITY EASEMENT
PVI POINT OF VERTICAL INTERSECTION
RC PELATIVE COMPACTION
RCP PENFORCED CONCRETE PIPE
ROW RIGHT-OF-MAY
RT RIGHT TUPN OR RIGHT
RPPA PEDUCED PRESSURE

RPPA REDUCED PRESSURE

PRINCIPLE ASSEMBLY

RW RETAINING WALL
SASD SACRAMENTO AREA SEWER DISTRICT

#### **UTILITY NOTE:**


THE UNDERGROUND UTILITIES SHOWN HAVE BEEN LOCATED FROM FIELD SURVEY INFORMATION AND EXISTING DRAWNINGS. THE ENGINEER MAKES NO GUARANTEE THAT THE UNDERGROUND UTILITIES SHOWN COMPRISE ALL SUCH UTILITIES IN THE AREA, EITHER IN SERVICE OR ABANDONED. THE ENGINEER FURTHER DOES NOT GUARANTEE THAT THE UNDERGROUND UTILITIES SHOWN ARE IN THE EXACT LOCATION INDICATED ALTHOUGH HE DOES CERTIFY THAT THEY ARE LOCATED AS ACCURATELY AS POSSIBLE FROM INFORMATION AVAILABLE. THE ENGINEER HAS NOT PHYSICALLY LOCATED THE UNDERGROUND UTILITIES.

	UTILITY CONTACT	INFORMATION	1
UTILITY	UTILITY CO.	REPRESENTATIVE	PHONE
TELEPHONE	CONSOLIDATED COMMUNICATIONS (CCI)		(916) 675-6370
GAS	PACIFIC GAS & ELECTRIC COMPANY (PG&E)	ENGINEERING	(877) 743-7782
ELECTRIC	PACIFIC GAS & ELECTRIC COMPANY (PG&E)	ENGINEERING	(877) 743-7782
FIRE	ROCKLIN FIRE DEPARTMENT	REGINALD WILLIAMS	(916) 625-5300
WATER	PLACER COUNTY WATER AGENCY (PCWA)	ENGINEERING	(530) 823-4886
SEWER	SOUTH PLACER MUNICIPAL UTILITY DISTRICT (SPMUD)	CARIE HUFF	(916) 786-8555
CABLE T.V.	WAVE BROADBAND		(866) 928-3123
DRAINAGE	CITY OF ROCKLIN	PUBLIC SERVICES	(916) 625-5500
U.S.A.	UNDERGROUND SER	RVICE ALERT	1-800-642-2444

EXISTING GENERAL PLAN: MIXED	USE (MU)	
ZONE: PLANNED DEVELOPMENT	COMMERCIAL (PD-C)	
USE: COMMERCIAL/RESIDENTIAL		
ITEM	REQUIREMENTS	PROVIDED
MINIMUM FRONT SETBACK	FT.	63.25 FT.
MINIMUM STREET SIDE SETBACK	FT.	12.5 FT. (FROM ACCESS ESMT.) 32.5 FT. (FROM PROPERTY LINE,
MINIMUM SIDE SETBACK	FT.	18 FT.
MINIMUM REAR SETEACK	FT.	179.5 FT.
MAXIMUM BUILDING HEIGHT	FT.	-
PROPERTY AREA: 1.60 AC GROS	SS	
REFERENCE IS MADE TO THE CIT	Y OF ROCKLIN ZONING	ORDINANCE

ITEM	REQUIREMENTS	PROVIDED
BUILDING SIZE	SF	2,443 SF (PANDA EXPRESS) 2,238 SF (PAD 2)
PARKING REQUIRED	1 SPACE PER EACH 3 SEATS IN RESTAURANTS	71 SPACES
MINIMUM PARKING DIMENSIONS	19 FT X 9 FT STD.* 8' X 16' COMPACTS*	19 FT X 9 FT STD. 17 FT & 2 FT OVERHANG X 9 FT STD 19 FT X 9 FT ACCESSIBLE
MIN. DRIVEWAY WIETH	25 FT.	25 FT.
ACCESSIBLE SPACES	3 SPACES	4 SPACES

RA	W EARTHWORK SUMMARY
CUT:	635 CY
FILL:	6015 CY
NET:	5380 CY (IMPORT)
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PRELIMINARY
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**VICINITY MAP** 
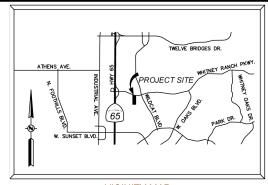
#### SHEET INDEX:

PRELIMINARY SITE PLAN

**EXISTING CONDITIONS** 

**TOPOGRAPHIC SURVEY:** 

PRELIMINARY GRADING, DRAINAGE, & PAVING PLAN

PRELIMINARY WATER & SANITARY SEWER PLAN

PRELIMINARY STORMWATER QUALITY PLAN

#### JURISDICTION:

TSD ENGINEERING, INC. SURVEY DATED: DECEMBER 2022

#### **BASIS OF BEARINGS:**

THE BASIS OF BEARINGS FOR THIS SURVEY IS IDENTICAL WITH THE WESTERLY BOUNDARY OF LOT 3, AS SHOWN ON THE FINAL MAP OF "WHITNEY RANCH LARGE LOT SUBDIVISION", FILED IN BOOK ZOF MAPS, AT PAGE 94, PLACER COUNTY RECORDS, ESTABLISHED FROM

THE BENCHMARK FOR THESE PLANS IS THE CITY OF ROCKLIN BENCHMARK NO. R10-6, BEING A 2" BRASS DISK IN A MONUMENT WELL AT "HE INTERSECTION OF IROQUOIS ROAD & SIOUX

ELEVATION = 171.23 FEET (NGVD29 - SURVEY DATUM). ELEVATION = 173.53 FEET (NAVD 88 - DATUM CONVERSION) DATUM CONVERSION: (NAVD 88) = (NGVD29) + 2.303 USFT ±0.033 USF

#### **ZONING FOR ALL PARCELS:**

PLANNED DEVELOPMENT COMMERCIAL (PD-C)

PROPOSED ZONING PLANNED DEVELOPMENT COMMERCIAL (PD-C)

#### FLOOD PLAIN:

SUBJECT PROPERTY IS LOCATED WITHIN ZONE "X". AREAS WITHIN ZONE "X" ARE DETERMINED TO BE OUTSIDE THE 0.2 ANNUAL CHANCE FLOOD PLAIN AS DETERMINED BY THE NATIONAL FLOOD INSURANCE PROGRAM FLOOD INSURANCE RATE MAP COMMUNITY DATED: NOVEMBER 2, 2018.

#### **GEOTECHNICAL REPORT:**

I DATED: MARCH 16, 2023

#### **DEVELOPER:**

CFT NV DEVELOPMENTS, LLC 1120 N. TOWN CENTER DRIVE, SUITE 150

#### PROPERTY OWNER:

OAKWOOD TRAILS 7V, LLC 1031 ROSEVILLE PARKWAY, #148 ROSEVILLE, CA 95678 CONTACT: PETER SAFTES PHONE: (916) 628-7778

SEE TENTATIVE PARCEL MAP

BY TSD ENGINEERING

#### PROPERTY INFORMATION:

PARCEL 2 AREA (N.A.P.)

EXISTING NUMBER OF PARCELS

PROPOSED NUMBER OF PARCELS

PARCEL 1 AREA (SUBJECT PARCEL) GROSS: 1.599± AC (69,669 SF) NET: 1.300± AC (56,621 SF)

GROSS: 1.400± AC (60.988 SF) NET: 1.394± AC (60,719 SF)

PARCEL 3 AREA (N.A.P.) GROSS: 8.592± AC (374,275 SF) NET: 8.523± AC (371,265 SF)

EXISTING USE VACANT

PROPOSED USE COMMERCIAL/RESIDENTIAL

EXISTING GENERAL PLAN DESIGNATION





Know what's below. Call before you dig.

or (800) 642-2444


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3 of 5 08/22/2023

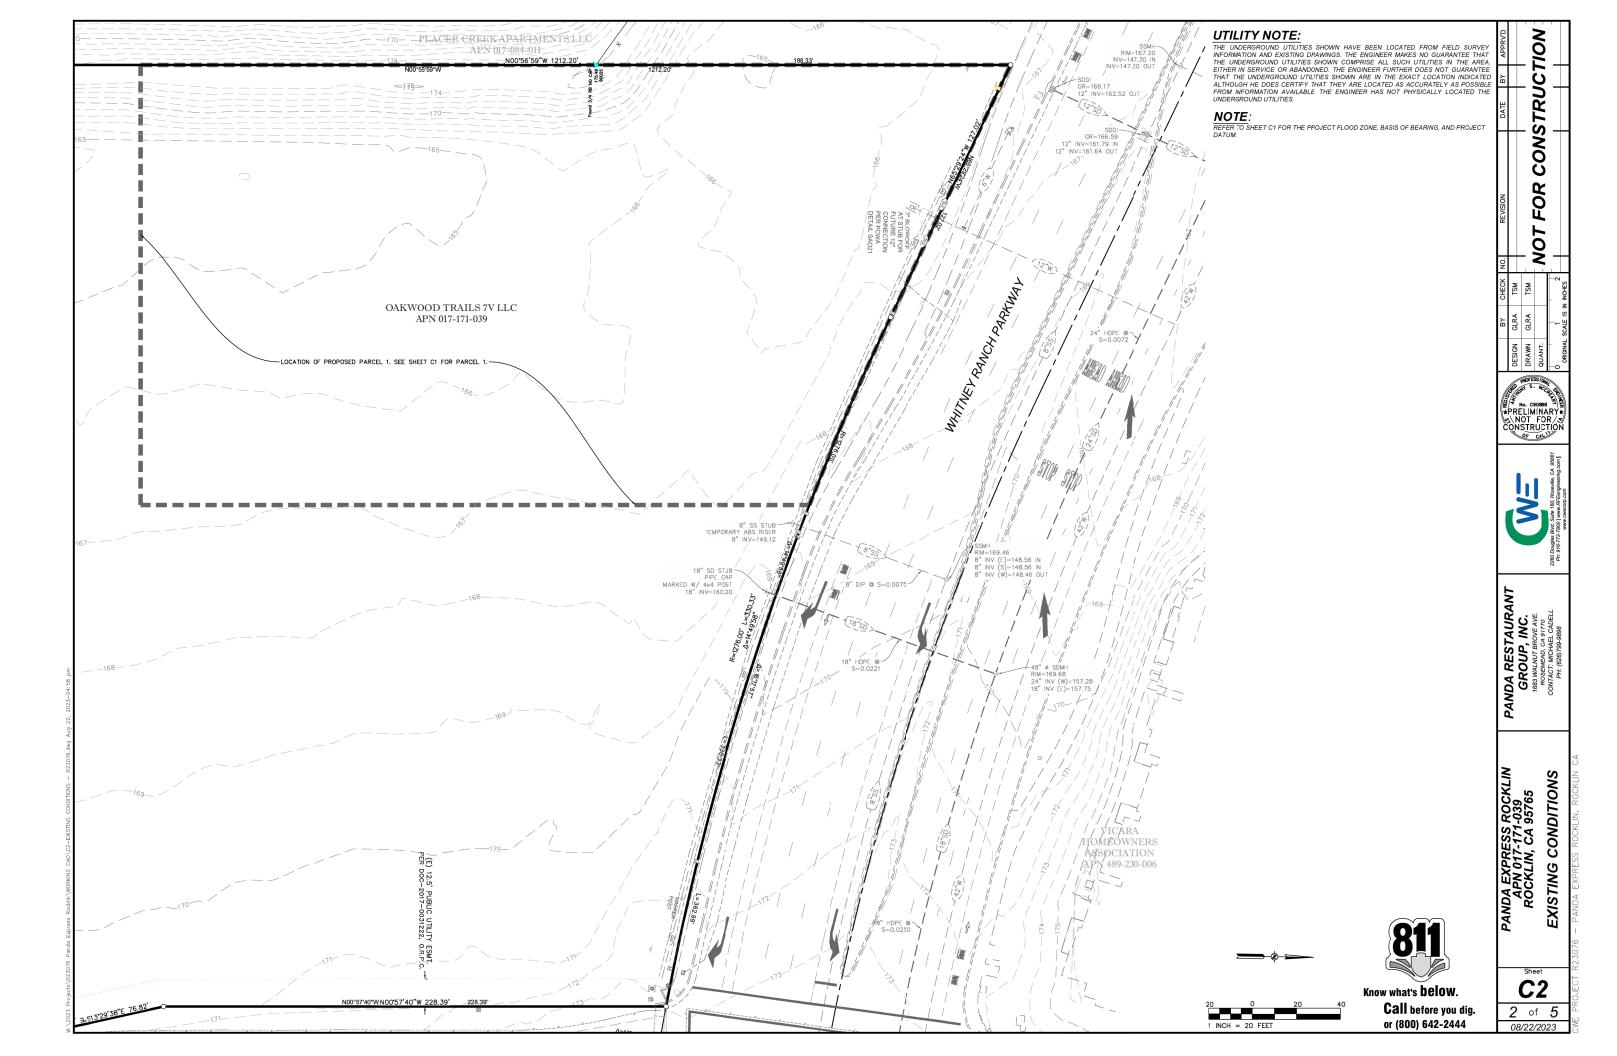

#### **SANITARY SEWER CONSTRUCTION KEYNOTES:**

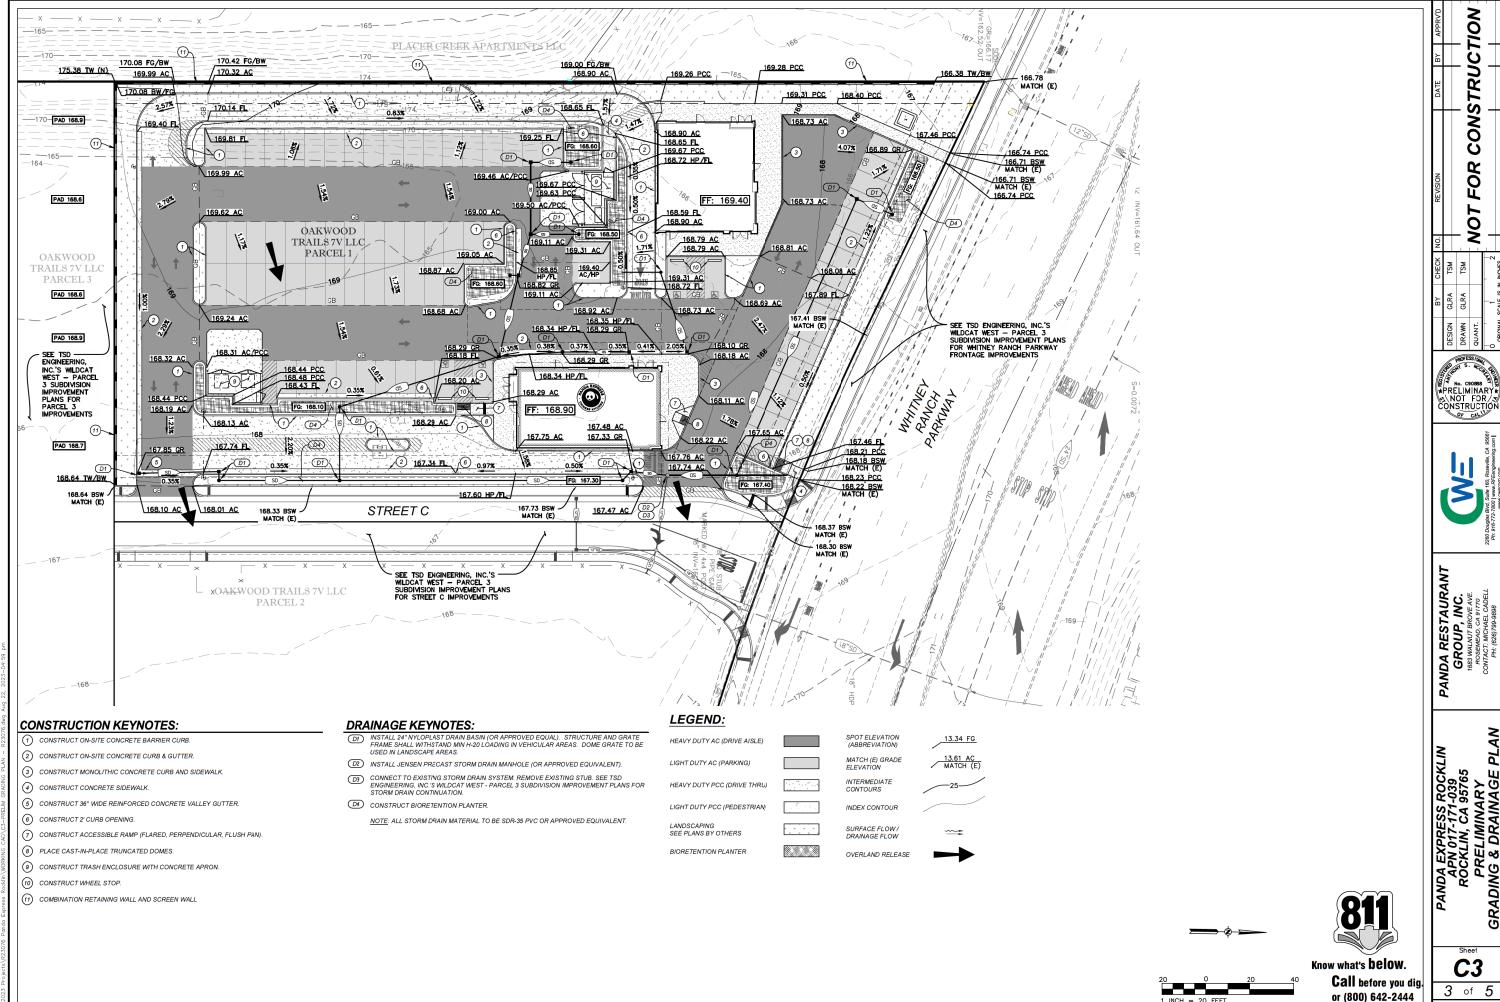- CONNECT (P) SANITARY SEWER SERVICE LATERAL TO (E) SEWER MAIN. SEE TSD ENGINEERING, INC.'S WILDCAT WEST PARCEL 3, SUBDIVISION IMPROVEMENT PLANS FOR STREET C SEWER IMPROVEMENTS.
- INSTALL NEW MANHOLE PER SPMUD STANDARDS AND CONNECTTO (E) SANITARY SEWER CLEANOUT. SEE TSD ENGINEERING, INC.'S WILDCAT WEST PARCEL 3, SUBDIVISION IMPROVEMENT PLANS FOR STREET C SEWER IMPROVEMENTS.
- **S4** INSTALL SANITARY SEWER CLEANOUT.
- <u>S5</u>
- <u>S6</u> INSTALL GREASE INTERCEPTOR.
- **S7** BUILDING GREASE SEWER POINT OF CONNECTION. INSTALL SEWER CLEANOUT.
- <u>S8</u> MANHOLE PER SPMUD STANDARDS.

#### **WATER CONSTRUCTION KEYNOTES:**

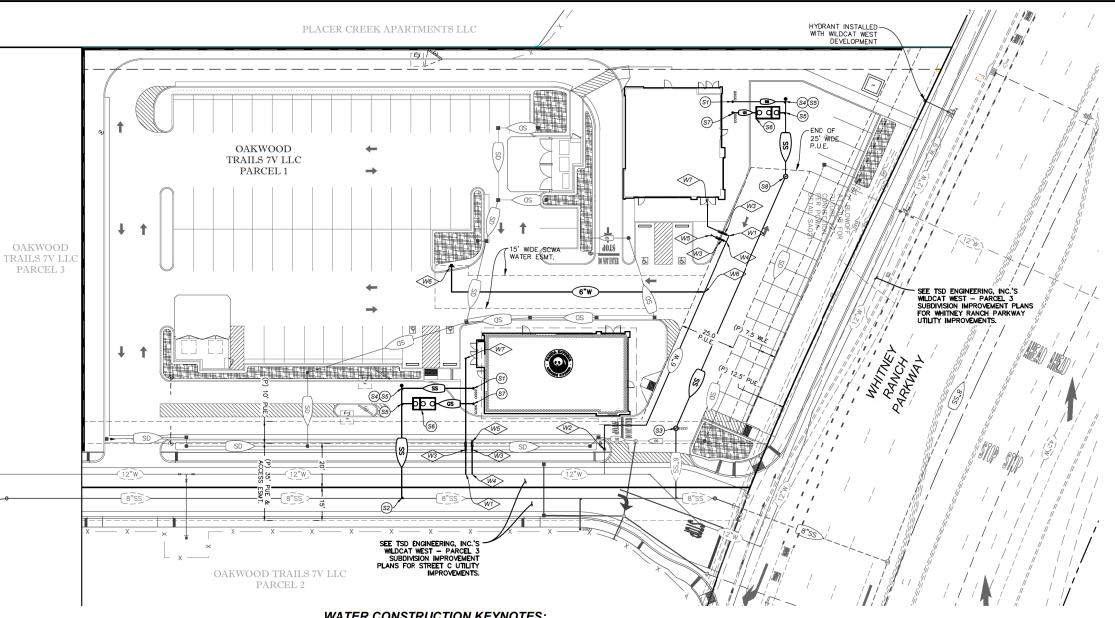- INSTALL 1" DOMESTIC WATER SERVICE TAP.
- REMOVE EXISTING ARV AND CONNECT TO EXISTING WATER LINE. SEE TSD ENGINEERING, NC.'S WILDCAT WEST PARCEL 3, SUBDIVISION IMPROVEMENT PLANS FOR STREET C WATER SYSTEM IMPROVEMENTS.
- INSTALL 1" WATER METER AND BACKFLOW PREVENTER.
- **₩**4> INSTALL 1" IRRIGATION WATER SERVICE TAP.
- 1" IRRIGATION SERVICE POINT OF CONNECTION. SEE LANDSCAPE FOR CONTINUATION.
- **₩**6> INSTALL FIRE HYDRANT ASSEMBLY.
- 1" DOMESTIC WATER POINT OF CONNECTION TO BUILDING







**4** of **5** 

